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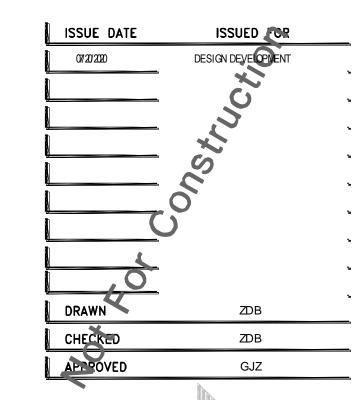
- MECHANICAL SCHEDULE SHEETS FOR ELECTRICAL REQUIREMENTS FOR MECHANICAL EQUIPMENT. PROVIDE ALL CONNECTIONS, STARTERS, DISCONNECTS, ETC. AS REQUIRED BY SCHEDULES AND WHERE NOTED ELSEWHERE. VERIFY REQUIREMENTS OF ALL MECHANICAL EQUIPMENT WITH SHOP DRAWINGS SUBMITTALS. NOTIFY ENGINEER OF ANY CONFLICTS BETWEEN EQUIPMENT SUBMITTALS AND ELECTRICAL DRAWINGS. WHERE CIRCUIT SIZES ARE SHOWN ON THE ELECTRICAL DRAWINGS THAT DIFFER FROM WHAT IS INDICATED ON THE MECHANICAL SCHEDULES, PRO VIDE THE CIRCUIT OF HIGHER AMPACITY.
- 10. REFER TO TEMPERATURE CONTROLS SHEETS FOR REQUIRED MOTOR CONTROLLERS. PROVIDE ALL ACCESSORIES INDICATED.
- 11. REFER TO LIGHTING CONTROL SCHEDULE FOR ROOM CONTROL AND EMERGENCY LIGHTING CIRCUIT CONTROL REQUIREMENTS. DESIGNATION FOR ROOM IS INDICATED AS A LETTERED OVAL SYMBOL.
- 12. ALL FIRE ALARM DEVICES SHALL BE COMPATIBLE WITH EXISTING FIRE ALARM SYSTEM. PROVIDE NECESSARY COMPONENTS, MODULES, ETC. AS REQUIRED FOR A FULLY FUNCTIONAL SYSTEM. RE—TEST AND CERTIFY EXISTING FIRE ALARM SYSTEM AT COMPLETION OF PROJECT.
- 13. CIRCUIT NEW EXIT SIGNS TO UNSWITCHED HOT LEG OF ADJACENT LIGHTING BRANCH

KEY PLAN

F

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F C E D



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F 248.656.7746 @ FRENCH ASSOCIATES, INC.

PROJECT

GROSSE PONTE

PUBLIC SO HOUS

BROWNELL MS

RENOVATIONS

GROSSE POINTE FARMS MICHIGAN

SHEET


UNT BFIRST FLOOR
POWERAND
ALMILIARY SYSTEMS
PLAN

PROJECT NUMBER

2019-030


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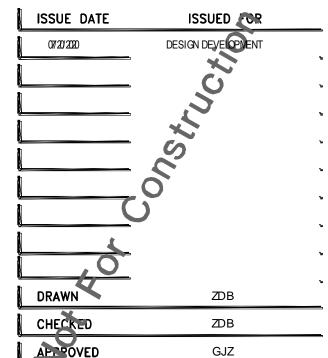
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KEY PLAN



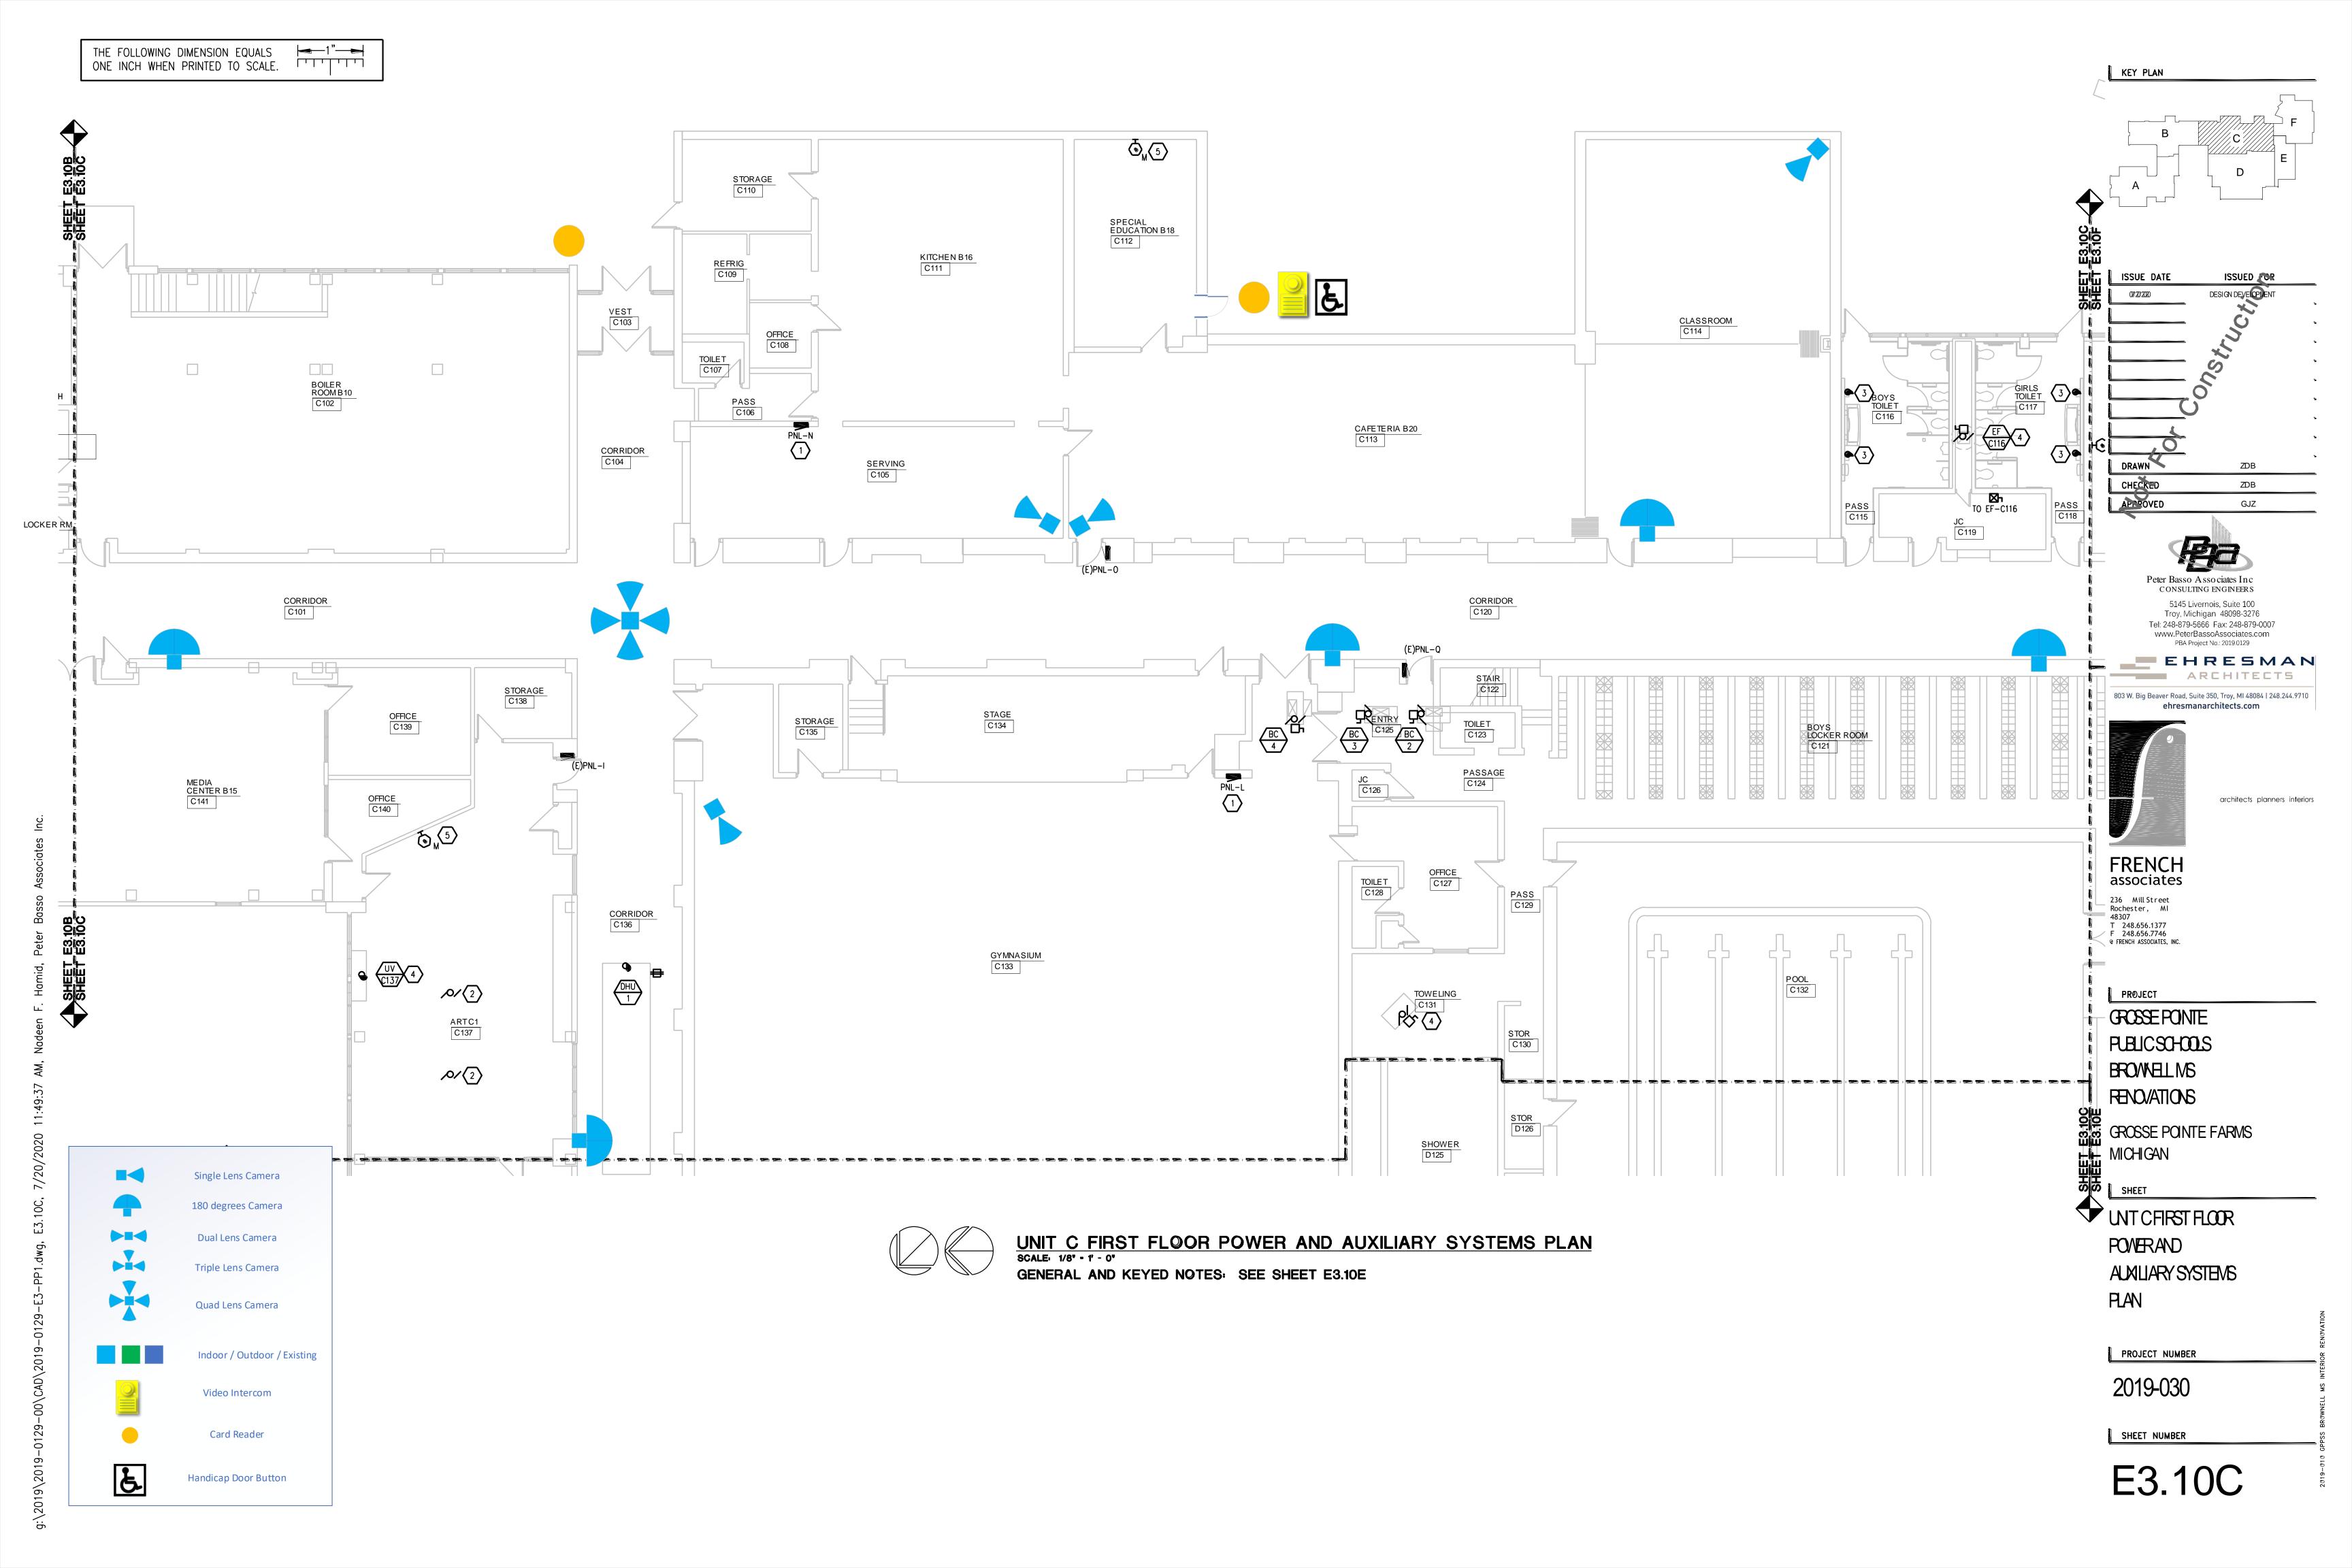




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PROJECT

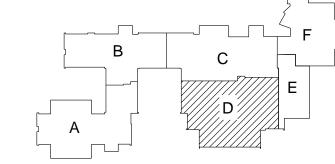GROSSE POINTE
PUBLIC SCHOOLS
BROWVELL MS
RENOVATIONS

GROSSE POINTE FARMS MICHIGAN

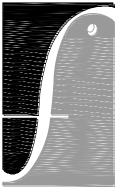
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UNT DFIRST FLOOR
POWERAND
AUXILIARY SYSTEMS
PLAN

2019-030

SHEET NUMBER

E3.10D

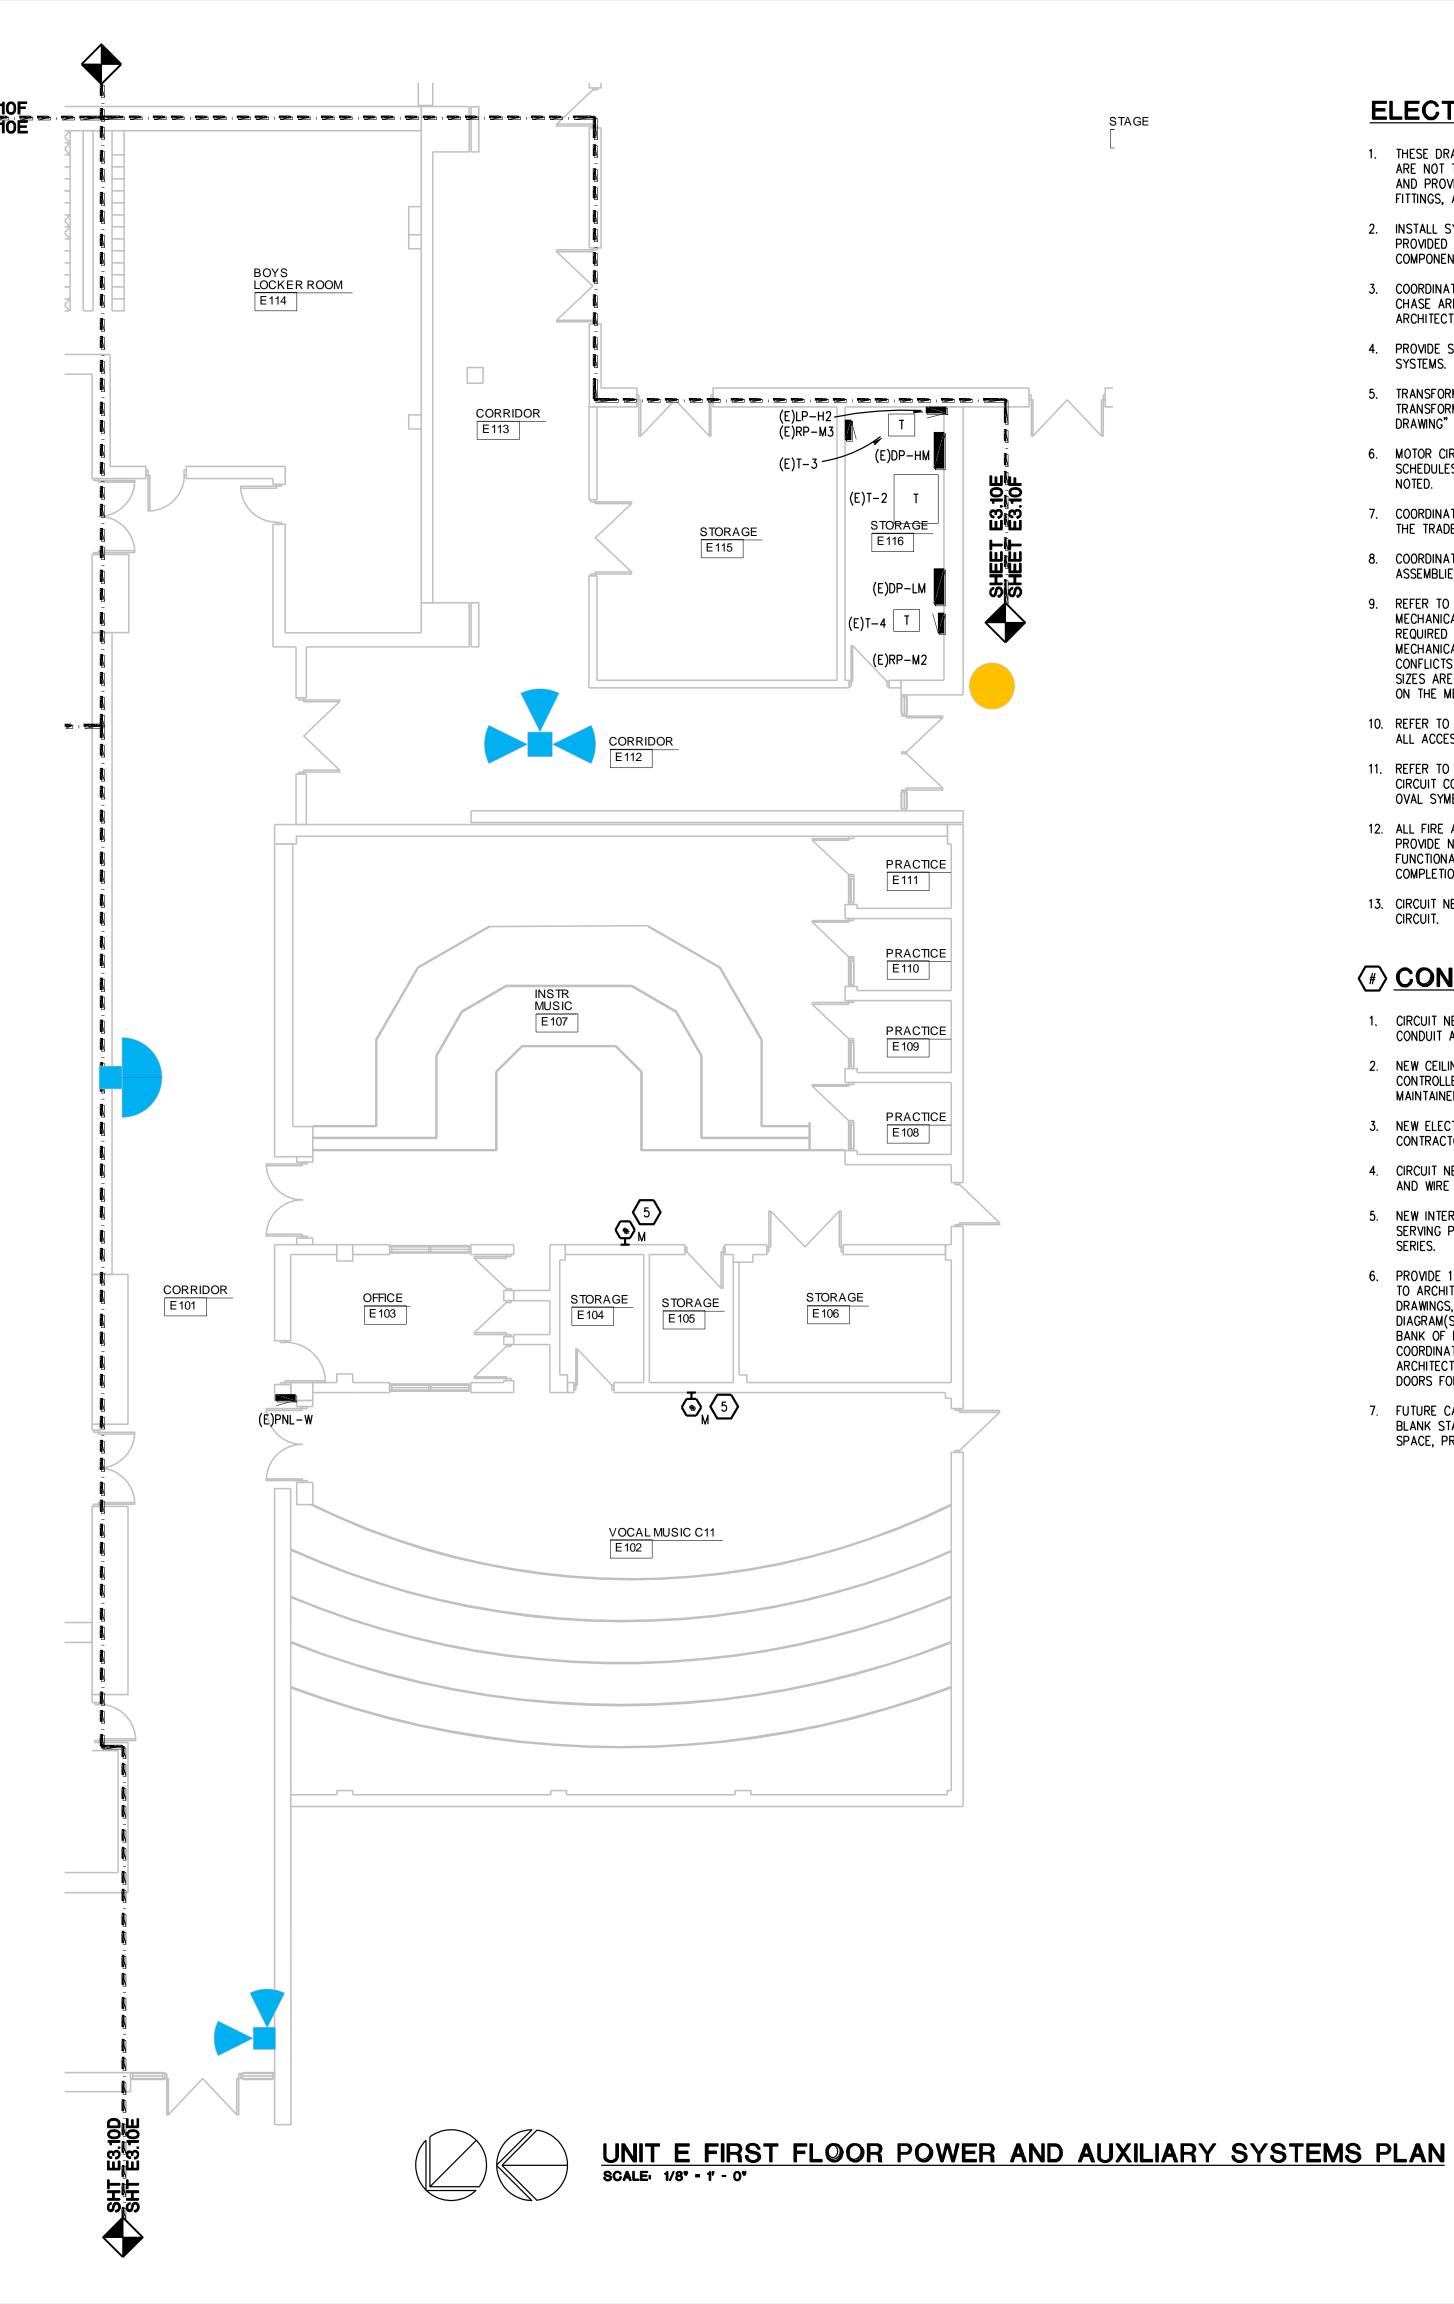


ELECTRICAL GENERAL NOTES:


- THESE DRAWINGS REPRESENT THE GENERAL EXTENT AND ARRANGEMENT OF SYSTEMS, BUT ARE NOT TO BE CONSIDERED FABRICATION DRAWINGS. COORDINATE WITH OTHER TRADES, AND PROVIDE EACH SYSTEM COMPLETE, INCLUDING ALL NECESSARY COMPONENTS, FITTINGS, AND OFFSETS.
- 2. INSTALL SYSTEMS SUCH THAT REQUIRED CLEARANCE AND SERVICE ACCESS SPACE IS PROVIDED AROUND ALL MECHANICAL AND ELECTRICAL EQUIPMENT, AND AROUND ANY COMPONENTS WHICH REQUIRE SERVICE ACCESS.
- COORDINATE AND PROVIDE ACCESS DOORS WITHIN INACCESSIBLE CEILING, SHAFT, AND CHASE AREAS FOR ALL COMPONENTS WHICH REQUIRE SERVICE ACCESS. REFER TO ARCHITECTURAL DRAWINGS FOR CEILING TYPES.
- 4. PROVIDE SUPPLEMENTARY STEEL AS REQUIRED FOR THE PROPER SUPPORT OF ALL SYSTEMS.
- 5. TRANSFORMER SECONDARY CONDUCTORS SHALL BE SIZED IN ACCORDANCE WITH TRANSFORMER CIRCUIT SIZING SCHEDULE SHOWN ON "ELECTRICAL STANDARD SCHEDULES DRAWING" UNLESS OTHERWISE NOTED.
- 6. MOTOR CIRCUIT PROTECTION SHALL BE SIZED IN ACCORDANCE WITH MOTOR CIRCUIT SIZING SCHEDULES SHOWN ON "ELECTRICAL STANDARD SCHEDULES DRAWING" UNLESS OTHERWISE NOTED.
- COORDINATE THE MOUNTING HEIGHTS OF DEVICES WITH ARCHITECTURAL ELEVATIONS AND THE TRADES INSTALLING THE WORK.
- 8. COORDINATE EXACT LOCATIONS OF ALL FLOOR SERVICE FITTINGS AND POKE-THROUGH ASSEMBLIES WITH FINAL FURNITURE LAYOUT DRAWINGS.
- 9. REFER TO MECHANICAL SCHEDULE SHEETS FOR ELECTRICAL REQUIREMENTS FOR MECHANICAL EQUIPMENT. PROVIDE ALL CONNECTIONS, STARTERS, DISCONNECTS, ETC. AS REQUIRED BY SCHEDULES AND WHERE NOTED ELSEWHERE. VERIFY REQUIREMENTS OF ALL MECHANICAL EQUIPMENT WITH SHOP DRAWINGS SUBMITTALS. NOTIFY ENGINEER OF ANY CONFLICTS BETWEEN EQUIPMENT SUBMITTALS AND ELECTRICAL DRAWINGS. WHERE CIRCUIT SIZES ARE SHOWN ON THE ELECTRICAL DRAWINGS THAT DIFFER FROM WHAT IS INDICATED ON THE MECHANICAL SCHEDULES, PROVIDE THE CIRCUIT OF HIGHER AMPACITY.
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- 12. ALL FIRE ALARM DEVICES SHALL BE COMPATIBLE WITH EXISTING FIRE ALARM SYSTEM. PROVIDE NECESSARY COMPONENTS, MODULES, ETC. AS REQUIRED FOR A FULLY FUNCTIONAL SYSTEM. RE—TEST AND CERTIFY EXISTING FIRE ALARM SYSTEM AT COMPLETION OF PROJECT.
- 13. CIRCUIT NEW EXIT SIGNS TO UNSWITCHED HOT LEG OF ADJACENT LIGHTING BRANCH CIRCUIT.

CONSTRUCTION KEY NOTES:

- CIRCUIT NEW PANELBOARD TO MAINTAINED FEEDERS AND BRANCH CIRCUITS. EXTEND CONDUIT AND WIRE AS REQUIRED.
- 2. NEW CEILING FAN. PROVIDE KITCHLER MODEL 330025WH AND NEW COMPATIBLE CONTROLLER, LOCATE NEW CONTROLS WHERE EXISTING WAS REMOVED. CIRCUIT TO MAINTAINED BRANCH CIRCUIT. EXTEND CONDUIT AND WIRE AS REQUIRED.
- 3. NEW ELECTRIC HAND DRYER, PROVIDED BY ARCHITECTURAL INSTALL BY ELECTRICAL CONTRACTOR. COORDINATE MOUNTING HEIGHT WITH ARCHITECT PRIOR TO ROUGH IN.
- 4. CIRCUIT NEW MECHANICAL EQUIPMENT TO MAINTAINED BRANCH CIRCUIT. EXTEND CONDUIT AND WIRE AS REQUIRED.
- 5. NEW INTERACTIVE FLAT PANEL (BY OTHERS). CIRCUIT TO BRANCH CIRCUIT PREVIOUSLY SERVING PROJECTOR. EXTEND CONDUIT AND WIRE AS REQUIRED. REFER TO DETAIL ON E7 SERIES.
- 6. PROVIDE 120V CIRCUITING IN CEILING SPACE FOR DOOR SECURITY AND CONTROLS. REFER TO ARCHITECTURAL FLOOR PLANS, DOOR HARDWARE SCHEDULE ON ARCHITECTURAL DRAWINGS, ACCESS CONTROL SYSTEM SPECIFICATION SECTION AND ACCESS CONTROL DIAGRAM(S) ON E7 SERIES FOR RACEWAYS AND BACK BOXES REQUIRED FOR DOOR OR BANK OF DOORS INDICATED. PROVIDE ALL REQUIRED RACEWAYS AND BACK BOXES. COORDINATE WITH DOOR HARDWARE CONTRACTOR. PROVIDE 1" CONDUIT FROM ARCHITECTURAL CASEWORK DOOR RELEASE BUTTON TO ACCESSIBLE CEILING SPACE ABOVE DOORS FOR SECURITY DOOR RELEASE.
- 7. FUTURE CARD ACCESS LOCATION. PROVIDE RECESSED SINGLE GANG JUNCTION BOX WITH BLANK STAINLESS STEEL FACE PLATE. STUB 1"C. UP INTO ACCESSIBLE CORRIDOR CEILING SPACE, PROVIDE NYLON PULL STRING WITH PLASTIC BUSHING ON END OF CONDUIT.

KEY PLAN

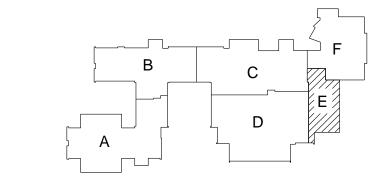

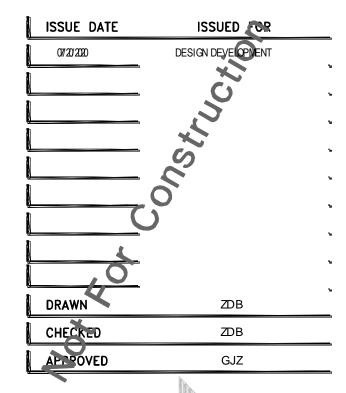



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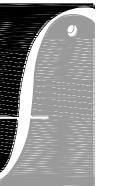
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PROJECT

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RENOVATIONS

GROSSE POINTE FARMS MICHIGAN

SHEET


UNTEFIRST FLOOR
POWERAND
ALMILIARY SYSTEMS
PLAN

PROJECT NUMBER

2019-030

SHEET NUMBER

E3.10E

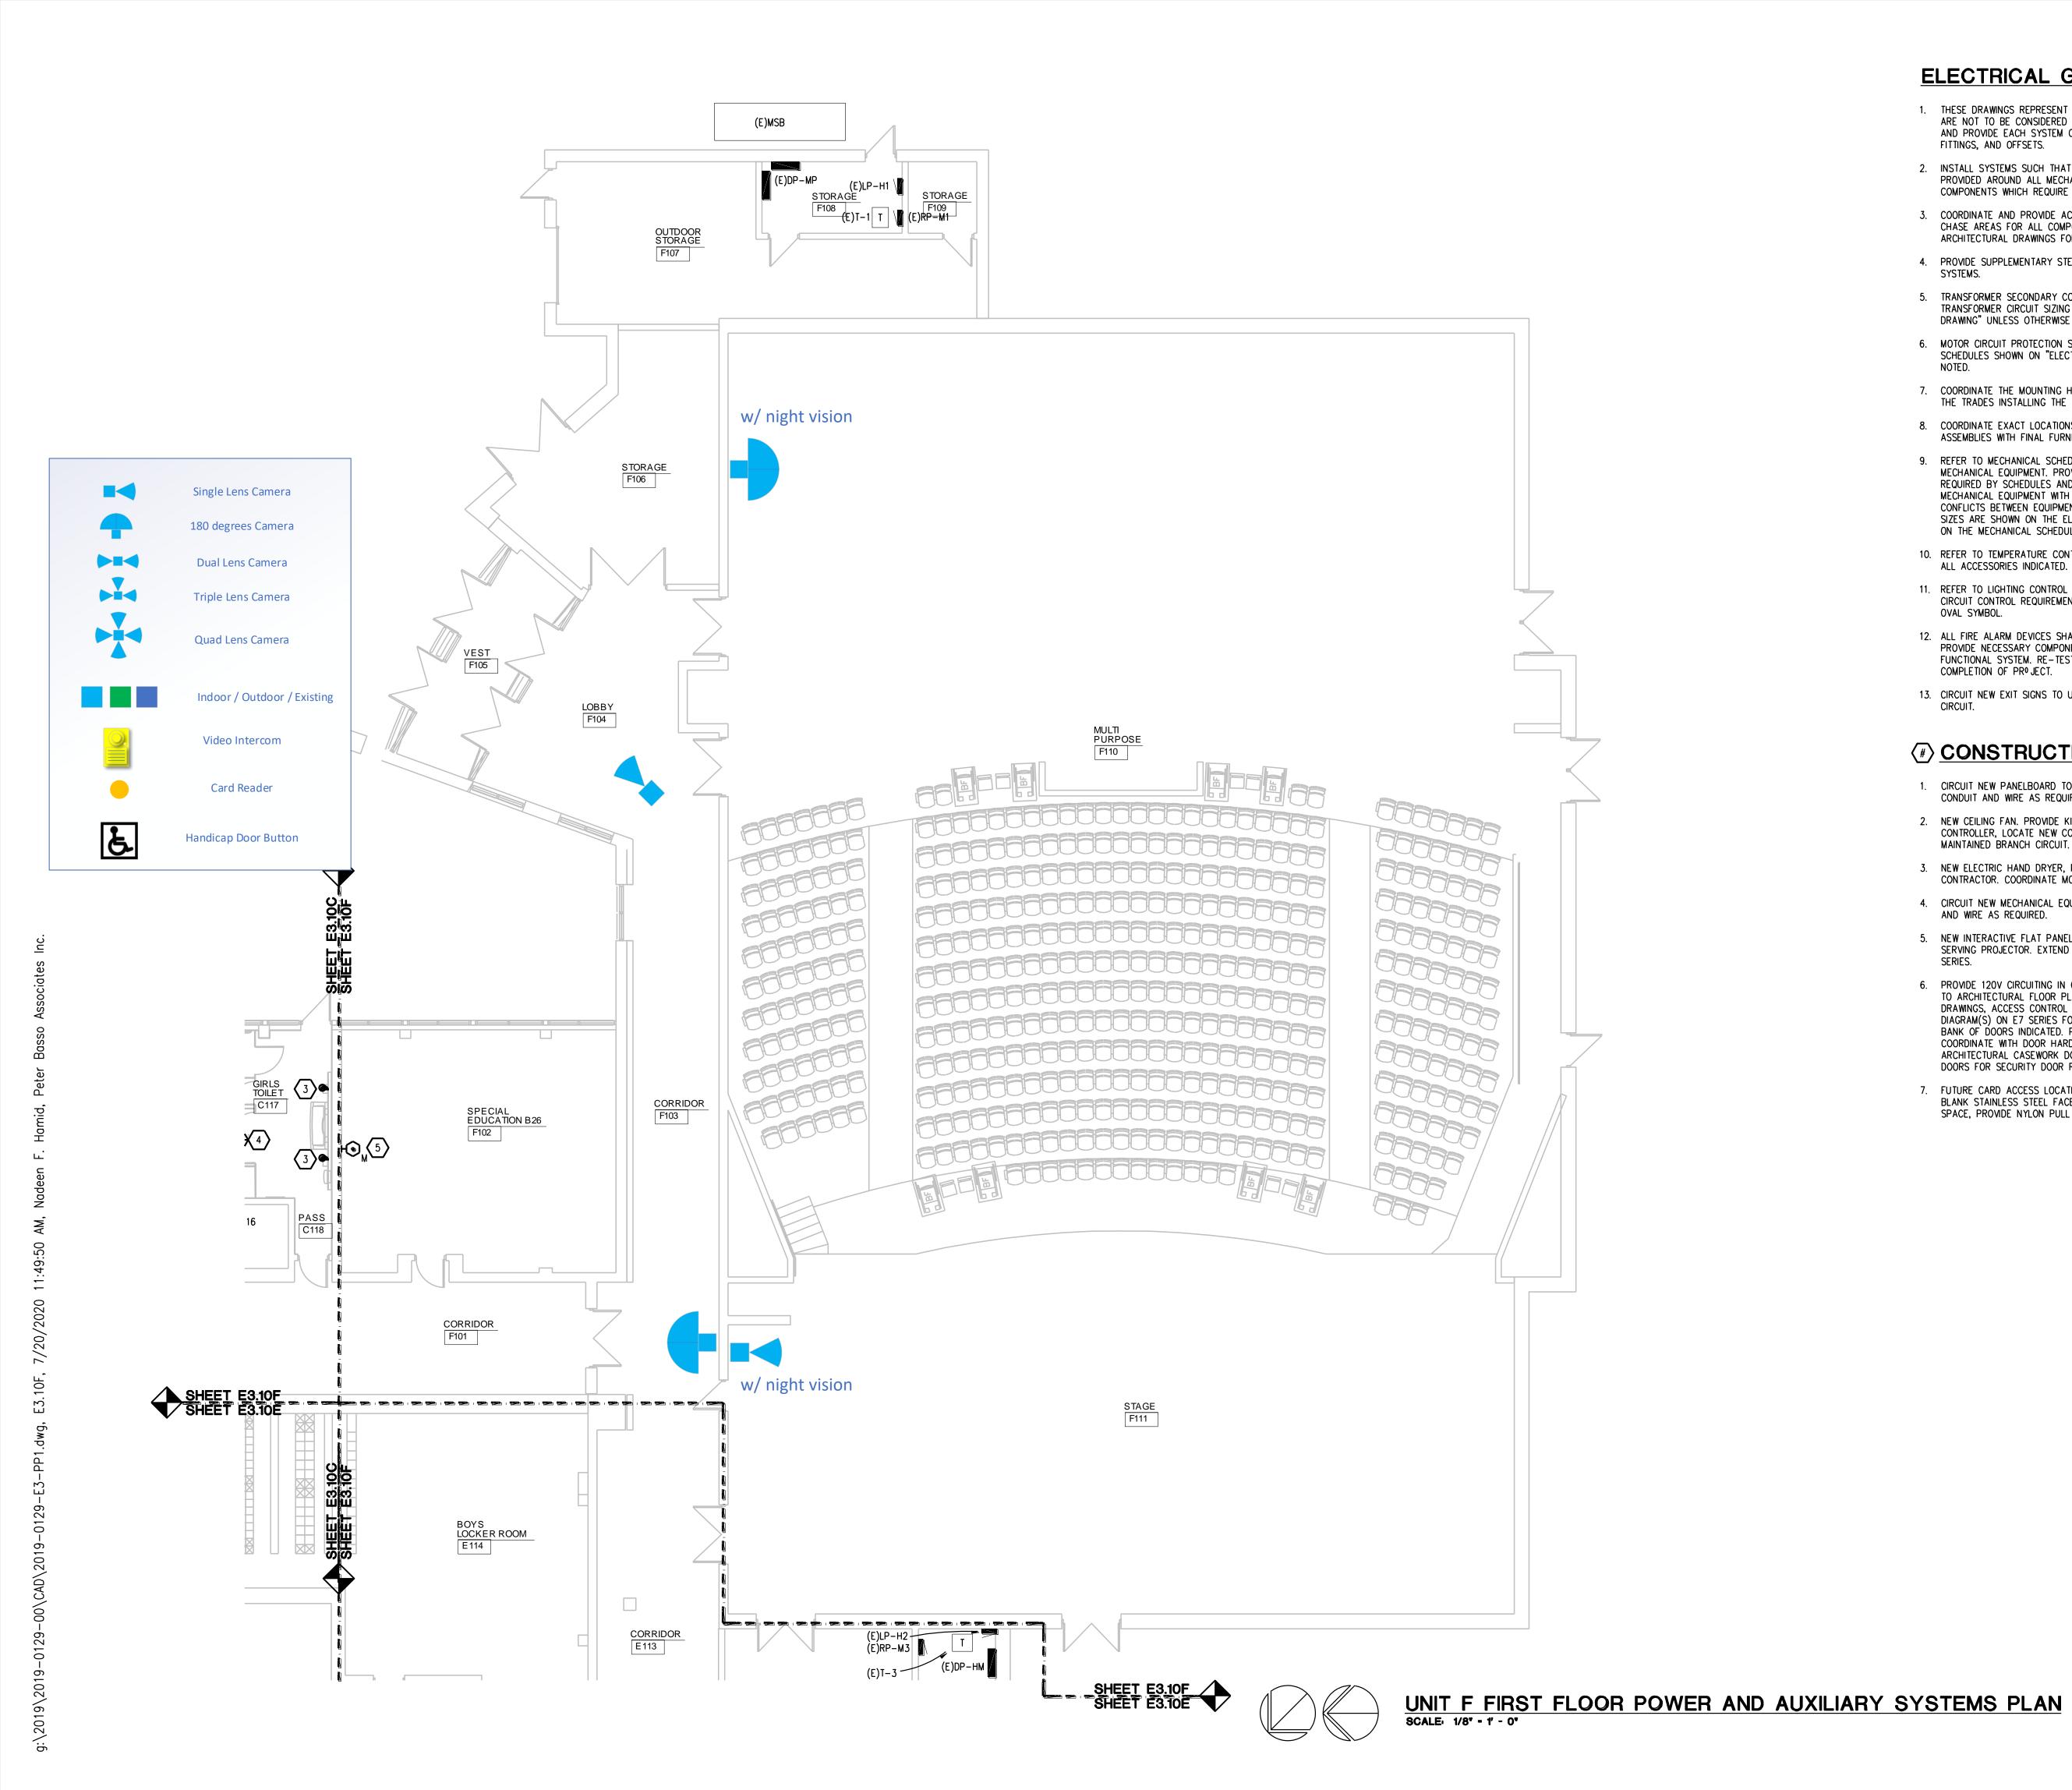


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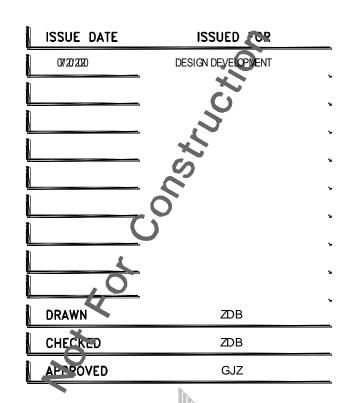
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KEY PLAN





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PROJECT

GROSSE PONTE
PUBLIC SO HOOLS
BROWNELL MS
RENOVATIONS

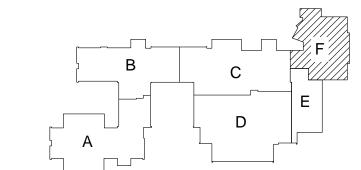GROSSE POINTE FARMS MICHIGAN

SHEET


UNTEFIRSTFLOOR
POWERAND
ALMILARY SYSTEMS
PLAN


PROJECT NUMBER

2019-030

SHEET NUMBER


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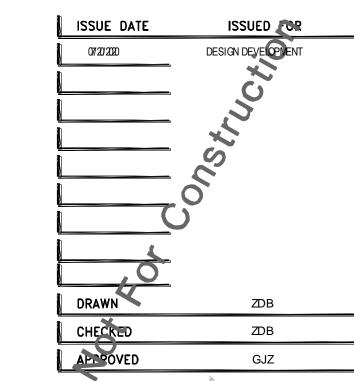


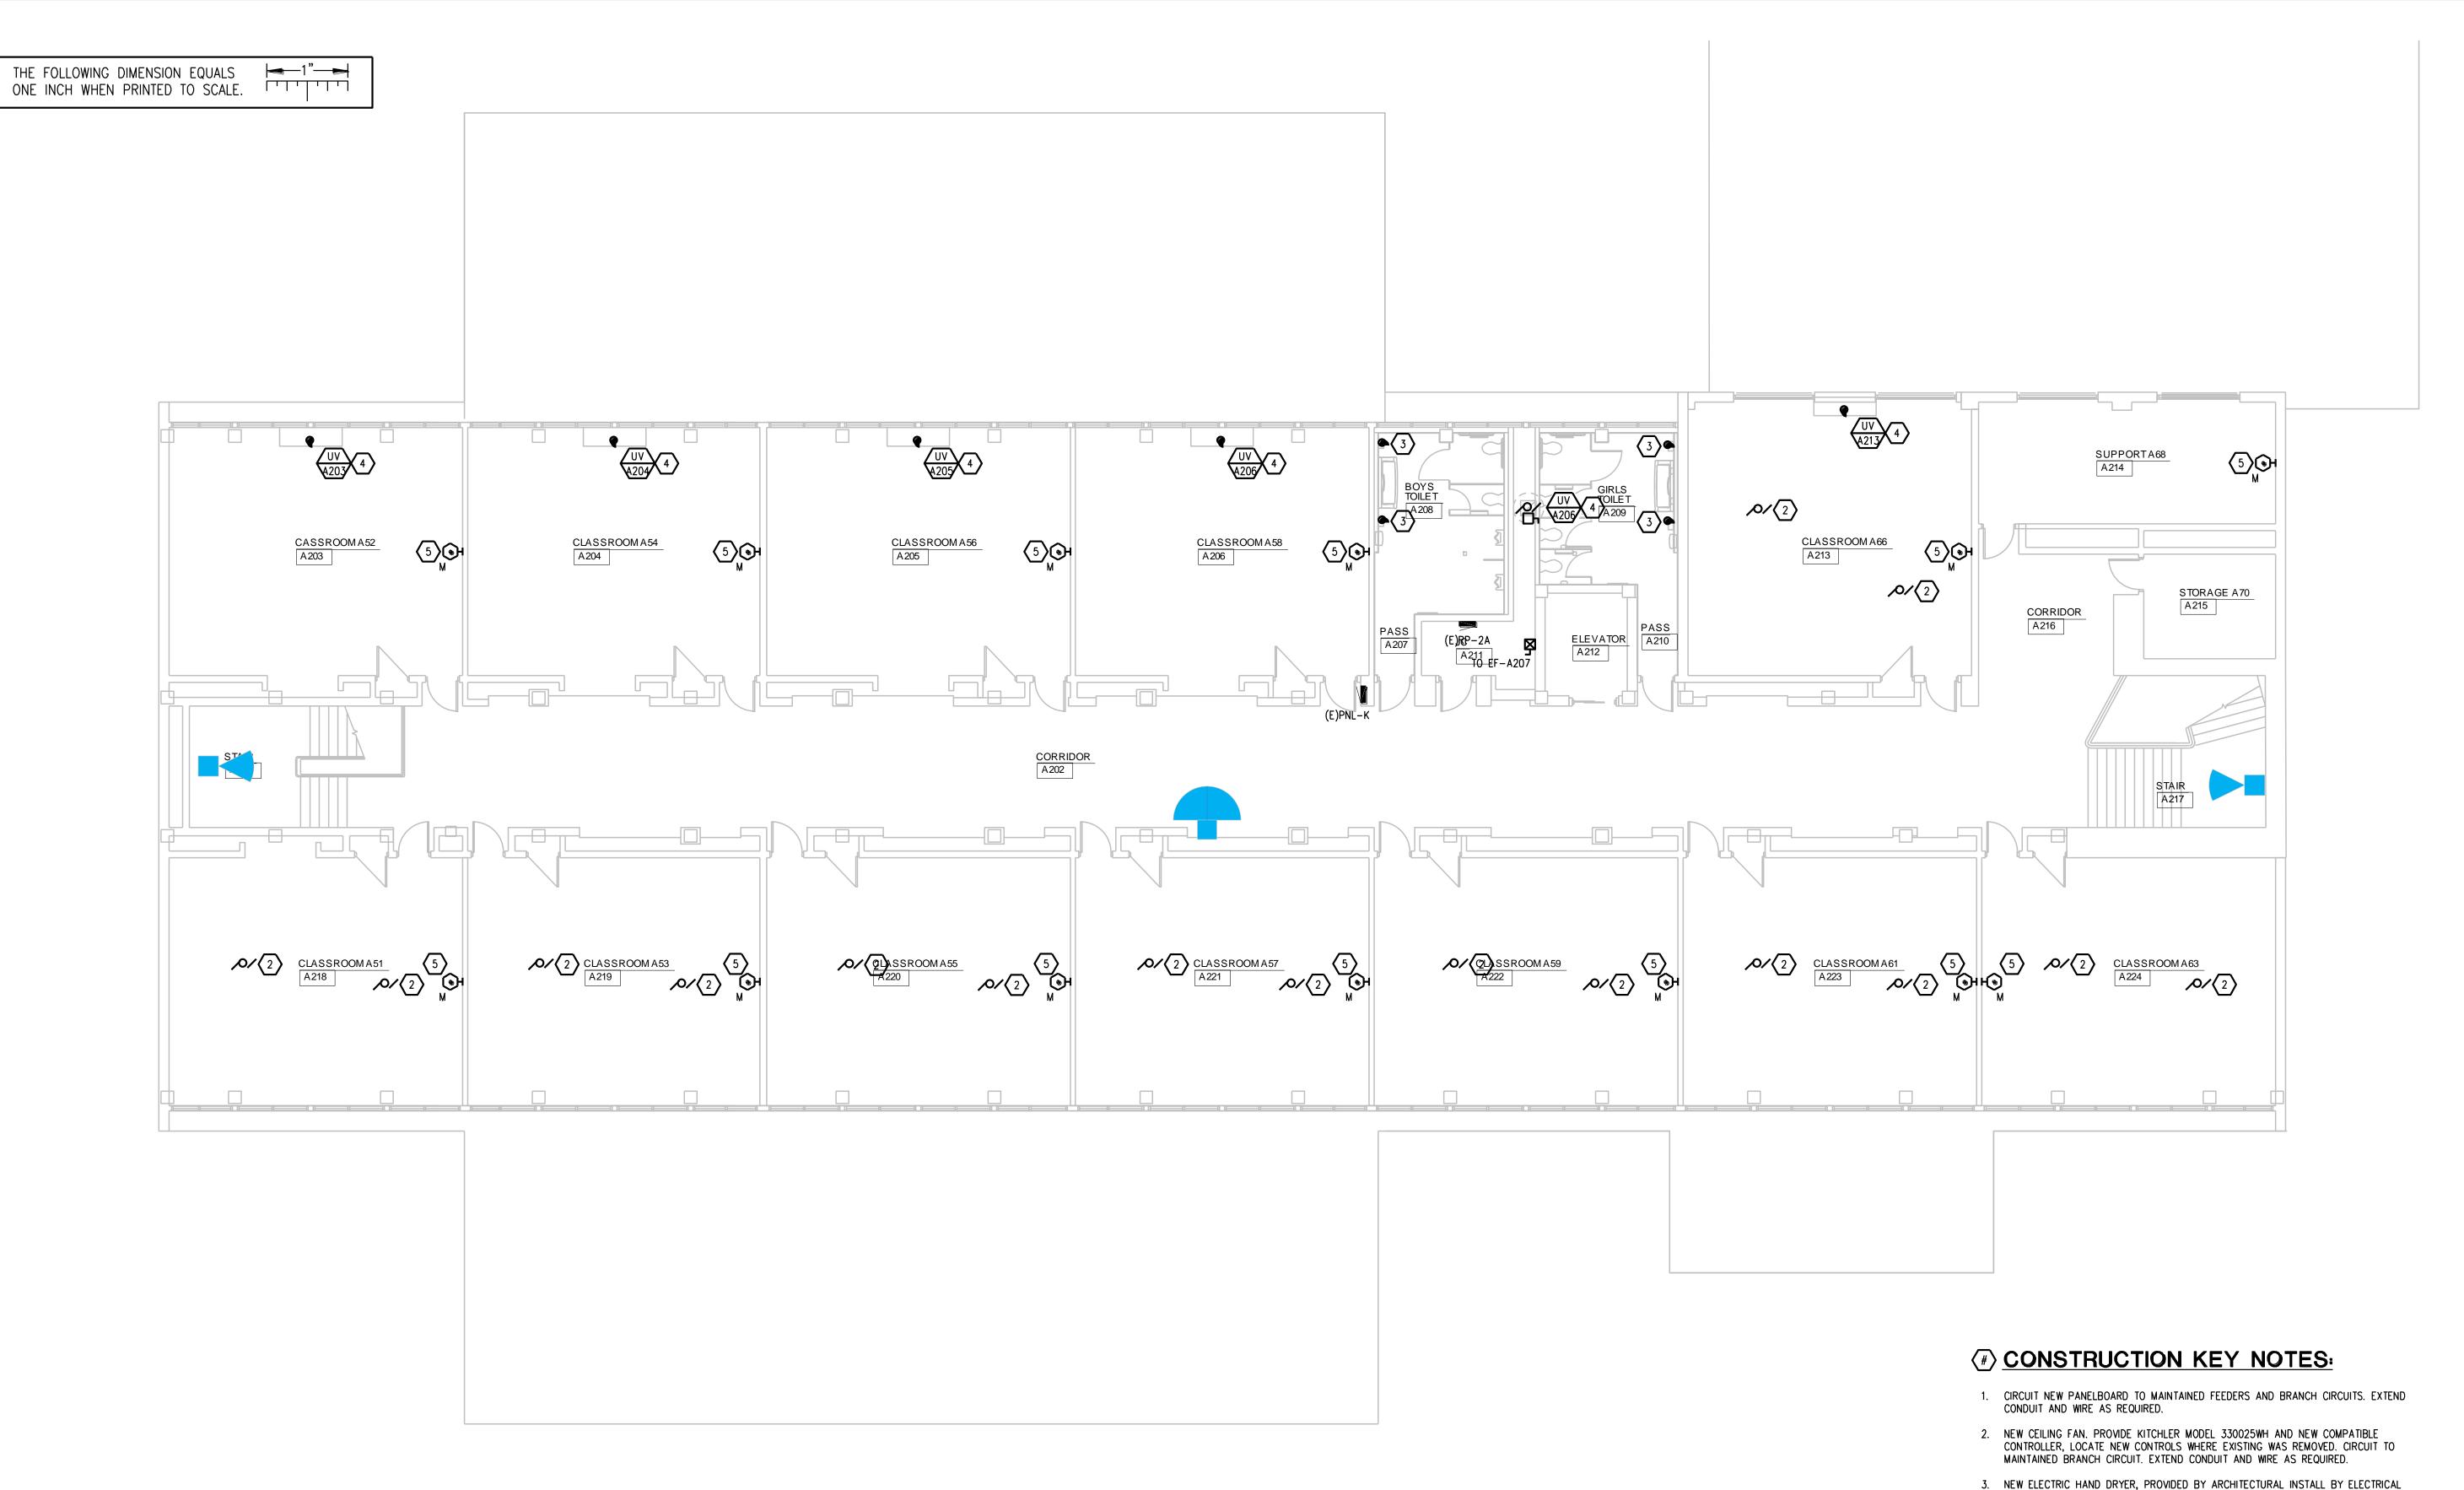

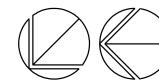UNIT A SECOND FLOOR POWER AND AUXILIARY SYSTEMS PLAN SCALE: 1/8" = 1' - 0"

KEY PLAN




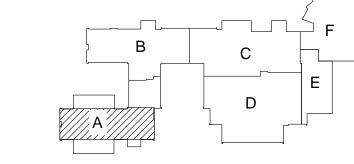

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PRØJECT

GROSSE POINTE PUBLIC SOHOOLS BROWLLINS RENOVATIONS

CROSSE POINTE FARMS MICHIGAN

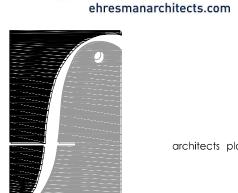SHEET

CONTRACTOR. COORDINATE MOUNTING HEIGHT WITH ARCHITECT PRIOR TO ROUGH IN.

4. CIRCUIT NEW MECHANICAL EQUIPMENT TO MAINTAINED BRANCH CIRCUIT. EXTEND CONDUIT

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TO ARCHITECTURAL FLOOR PLANS, DOOR HARDWARE SCHEDULE ON ARCHITECTURAL DRAWINGS, ACCESS CONTROL SYSTEM SPECIFICATION SECTION AND ACCESS CONTROL DIAGRAM(S) ON E7 SERIES FOR RACEWAYS AND BACK BOXES REQUIRED FOR DOOR OR BANK OF DOORS INDICATED. PROVIDE ALL REQUIRED RACEWAYS AND BACK BOXES. COORDINATE WITH DOOR HARDWARE CONTRACTOR, PROVIDE 1" CONDUIT FROM

7. FUTURE CARD ACCESS LOCATION. PROVIDE RECESSED SINGLE GANG JUNCTION BOX WITH BLANK STAINLESS STEEL FACE PLATE. STUB 1"C. UP INTO ACCESSIBLE CORRIDOR CEILING SPACE, PROVIDE NYLON PULL STRING WITH PLASTIC BUSHING ON END OF CONDUIT.

ARCHITECTURAL CASEWORK DOOR RELEASE BUTTON TO ACCESSIBLE CEILING SPACE ABOVE

AND WIRE AS REQUIRED.

DOORS FOR SECURITY DOOR RELEASE.

SERIES.

UNTASECOND FLOORPOWERAND ALMUARY SYSTEMS PLAN


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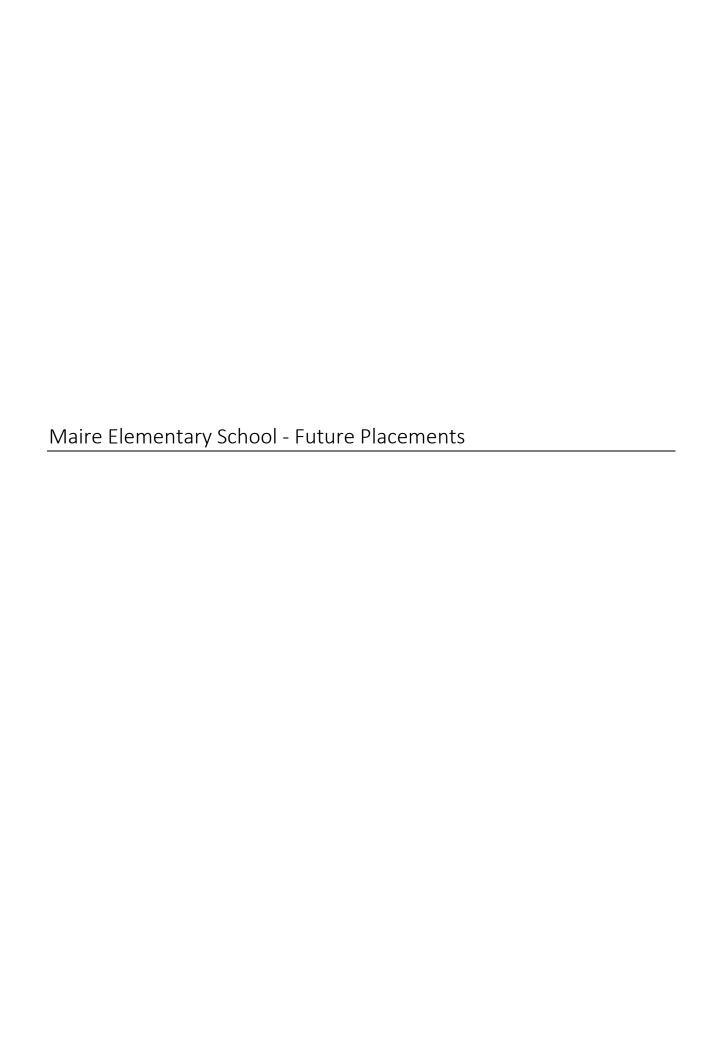
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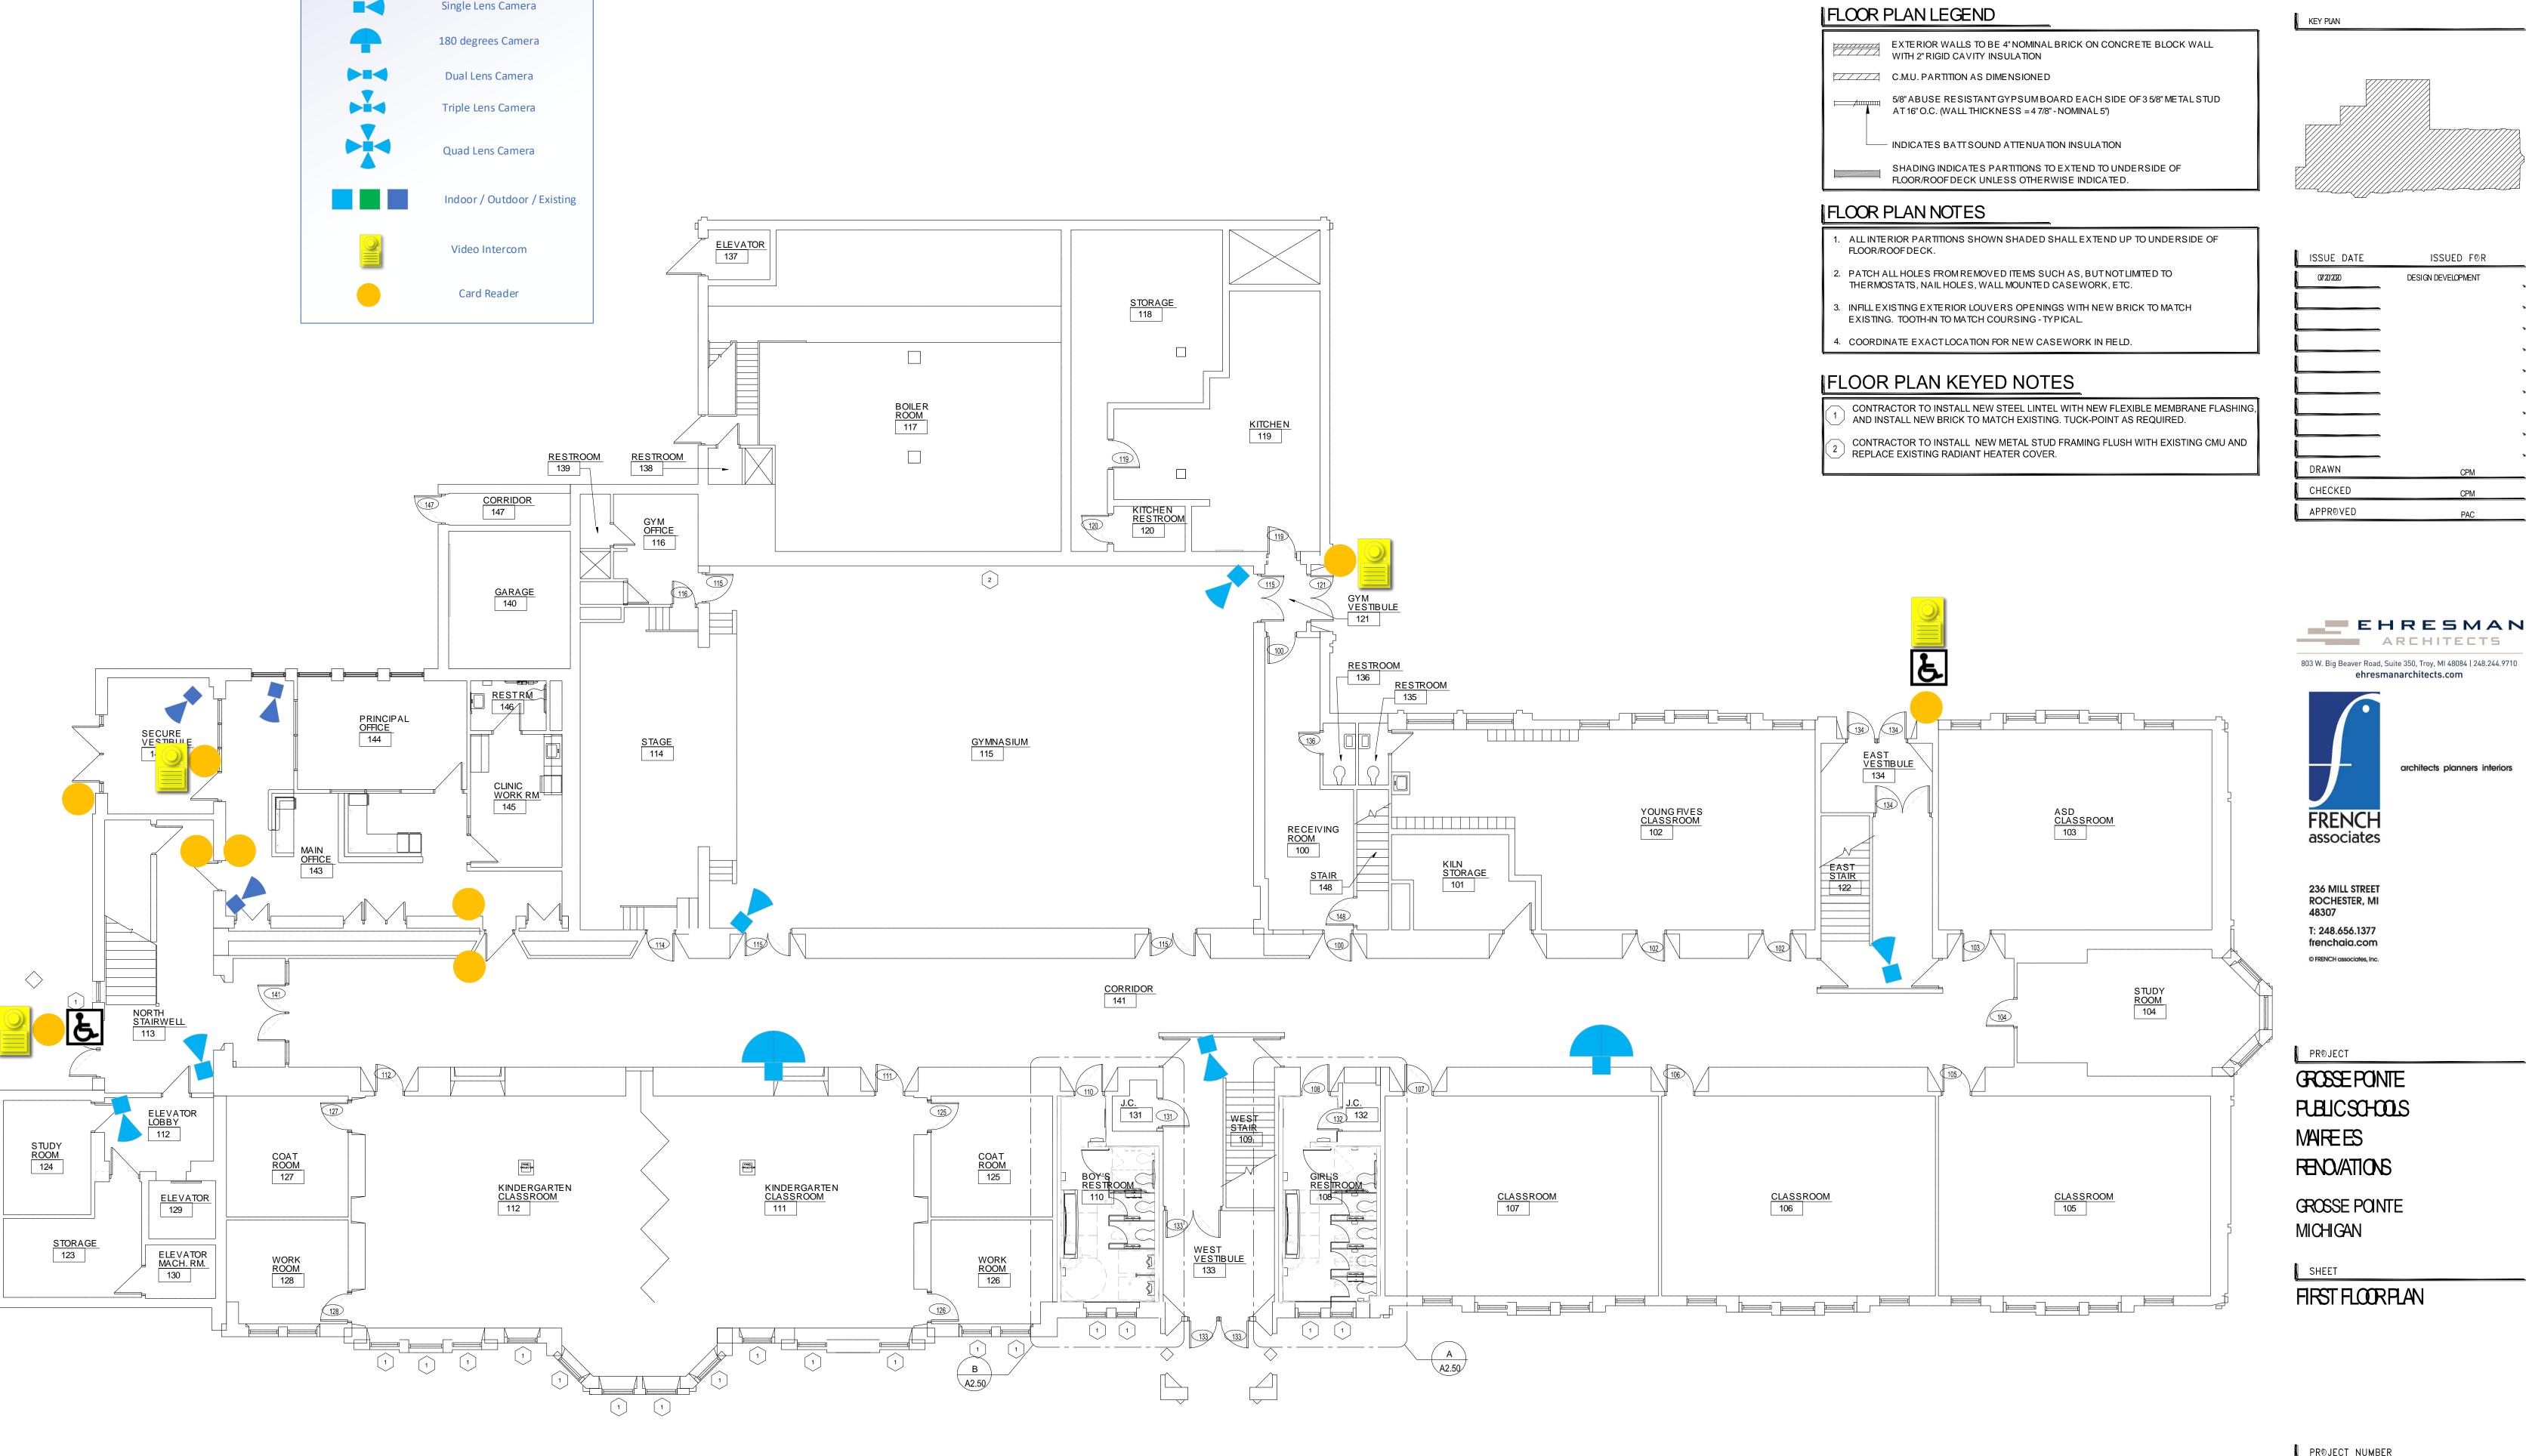
SHEET NUMBER

E3.20A

GENERAL NOTES: SEE SHEET E3.10E





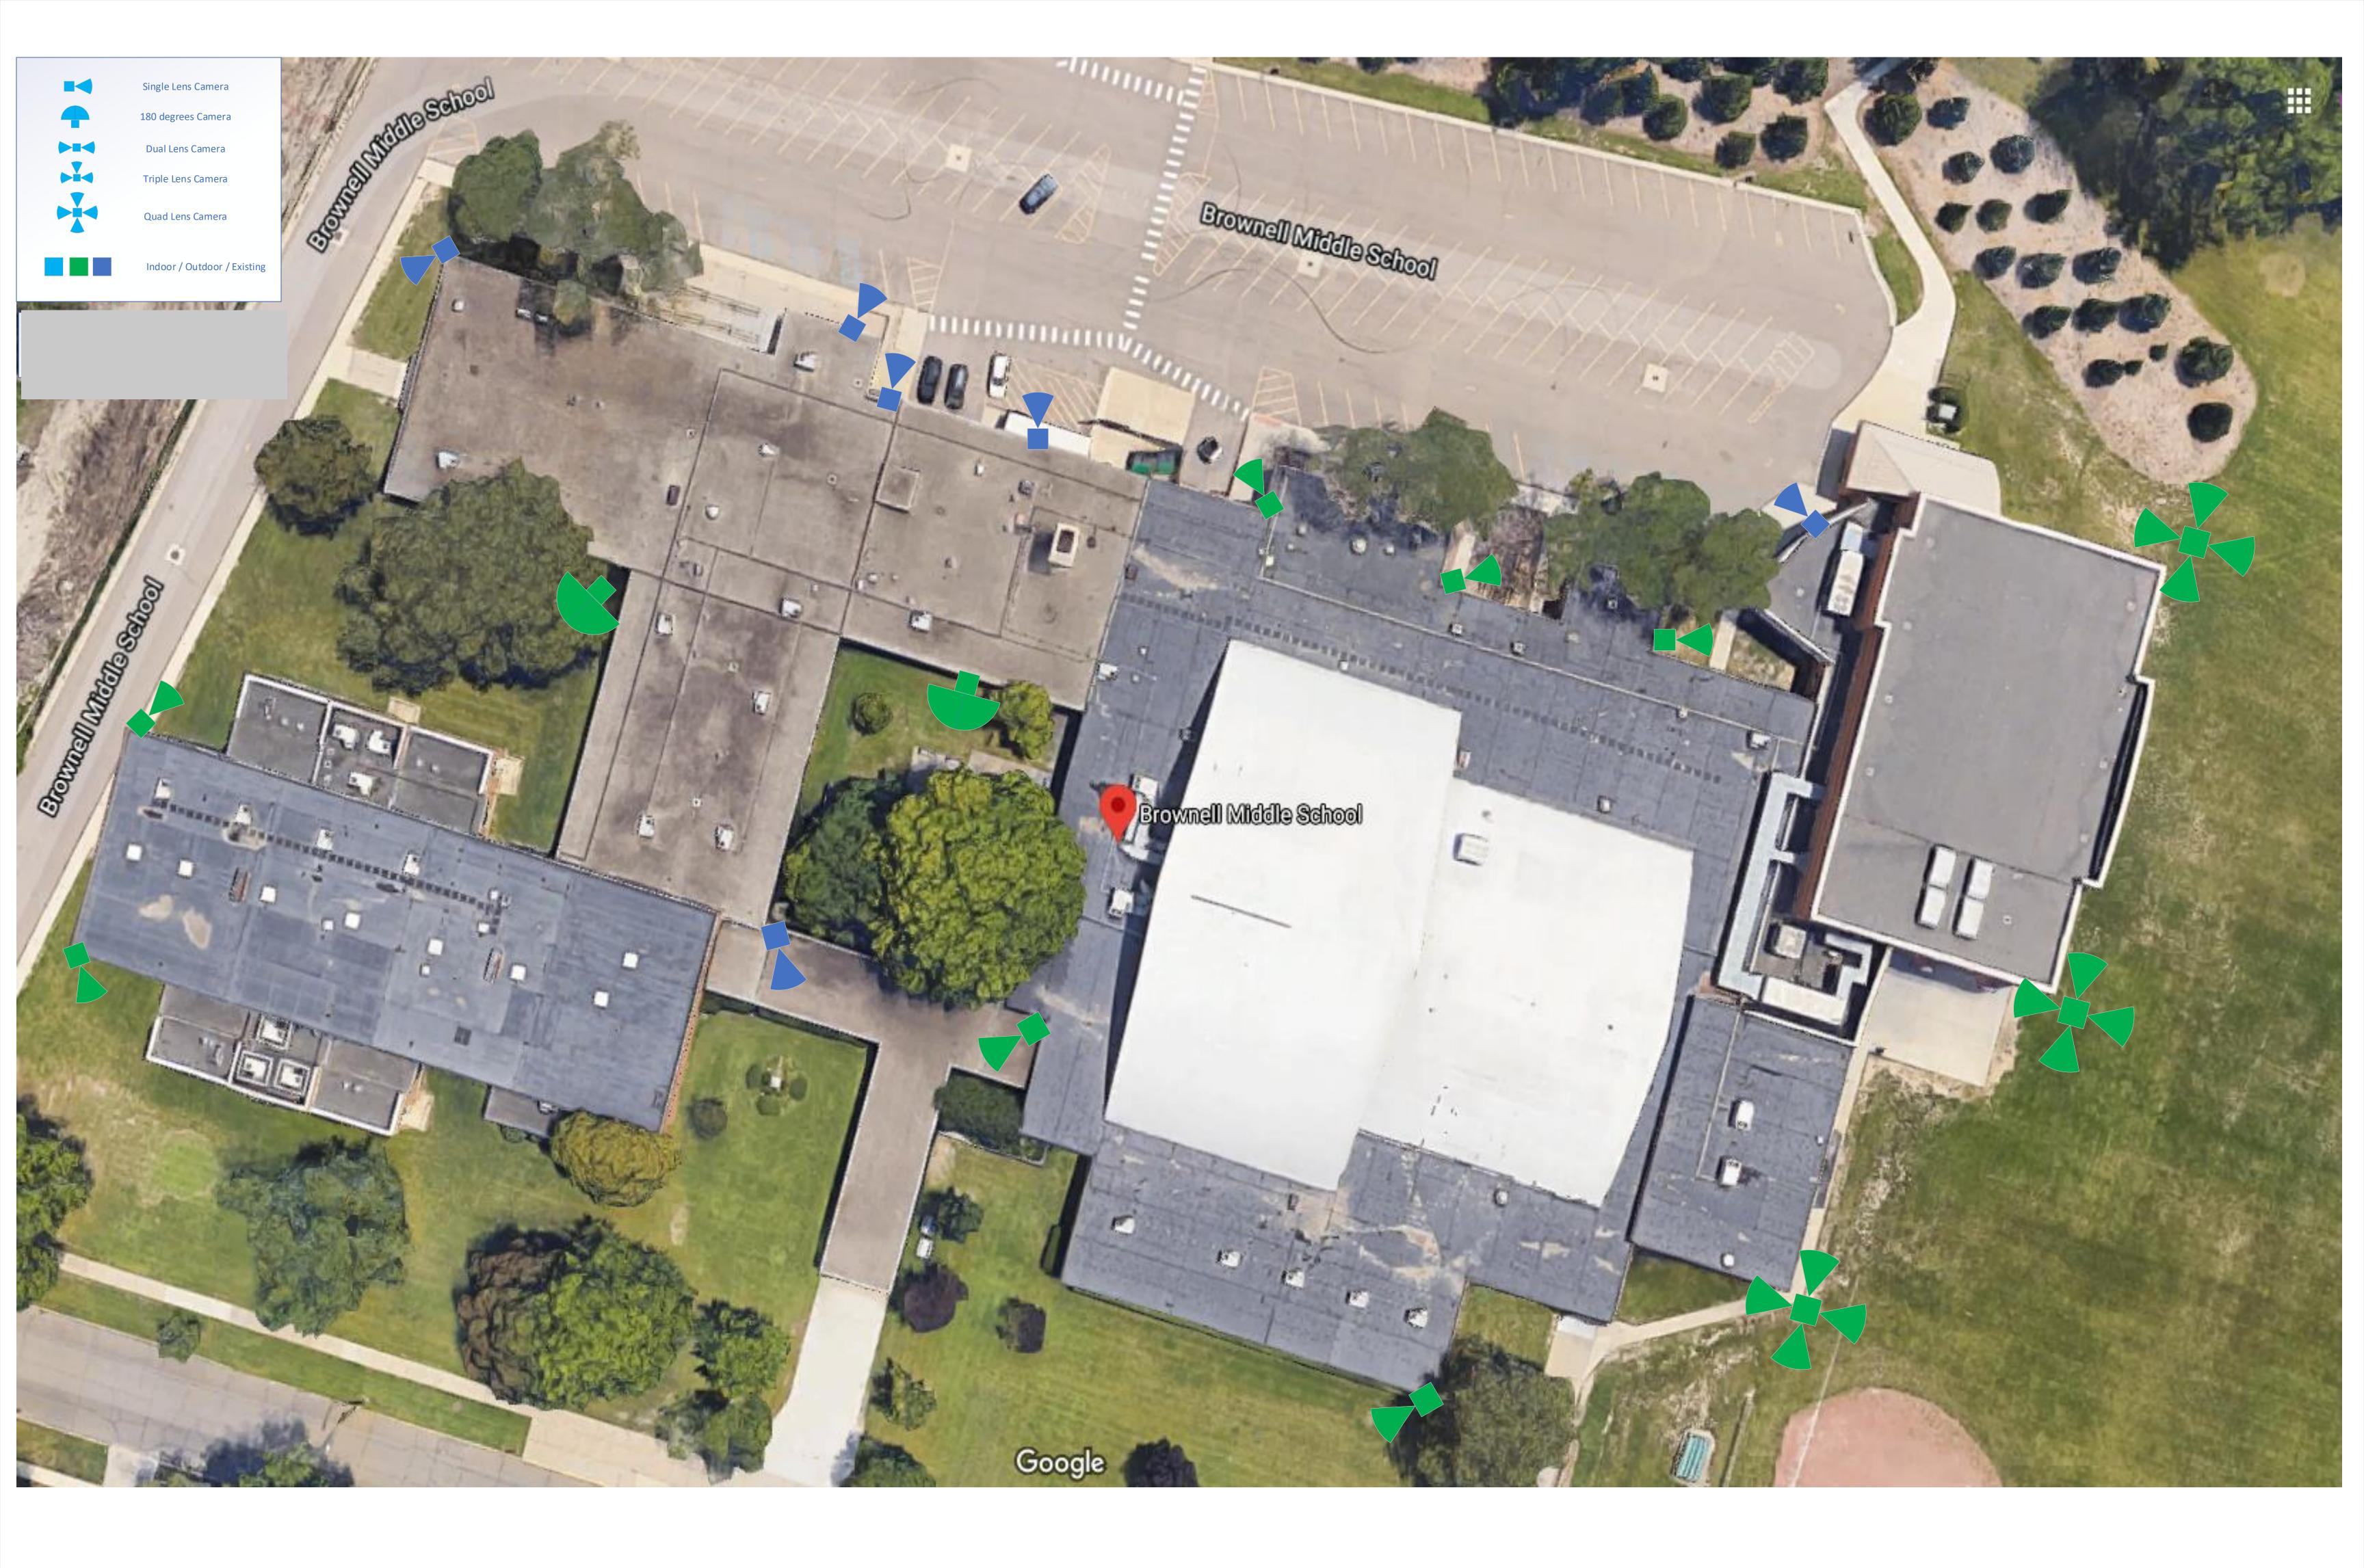




PRØJECT NUMBER

2019-026

SHEET NUMBER

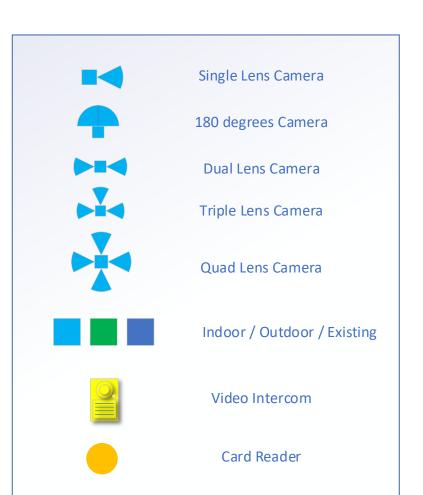



EXTERIOR WALLS TO BE 4" NOMINAL BRICK ON CONCRETE BLOCK WALL WITH 2" RIGID CAVITY INSULATION

C.M.U. PARTITION AS DIMENSIONED

5/8" ABUSE RESISTANT GYPSUM BOARD EACH SIDE OF 3 5/8" METAL STUD AT 16" O.C. (WALL THICKNESS = 47/8" - NOMINAL 5")

INDICATES BATT SOUND ATTENUATION INSULATION


SHADING INDICATES PARTITIONS TO EXTEND TO UNDERSIDE OF FLOOR/ROOF DECK UNLESS OTHERWISE INDICATED.

FLOOR PLAN NOTES

- ALL INTERIOR PARTITIONS SHOWN SHADED SHALL EXTEND UP TO UNDERSIDE OF FLOOR/ROOF DECK.
- 2. PATCH ALL HOLES FROM REMOVED ITEMS SUCH AS, BUT NOT LIMITED TO THERMOSTATS, NAIL HOLES, WALL MOUNTED CASEWORK, ETC.
- 3. INFILL EXISTING EXTERIOR LOUVERS OPENINGS WITH NEW BRICK TO MATCH EXISTING. TOOTH-IN TO MATCH COURSING TYPICAL.
- 4. COORDINATE EXACTLOCATION FOR NEW CASEWORK IN FIELD.

FLOOR PLAN KEYED NOTES

- CONTRACTOR TO INSTALL NEW STEEL LINTEL WITH NEW FLEXIBLE MEMBRANE FLASHING, AND INSTALL NEW BRICK TO MATCH EXISTING. TUCK-POINT AS REQUIRED.
- CONTRACTOR TO INSTALL NEW METAL STUD FRAMING FLUSH WITH EXISTING CMU AND REPLACE EXISTING RADIANT HEATER COVER.

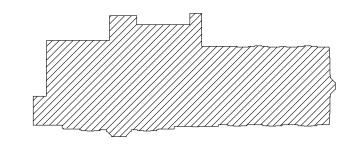


KEY PLAN

ISSUE DATE


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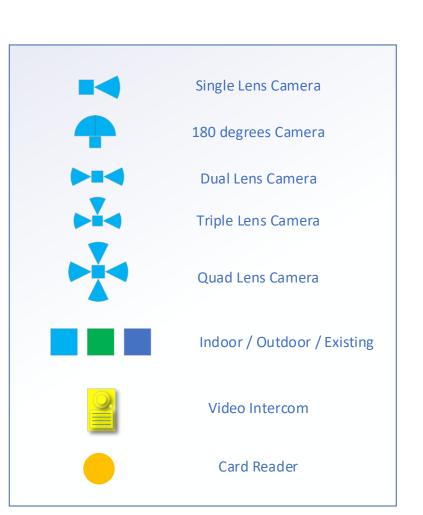
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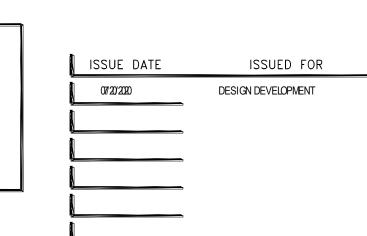
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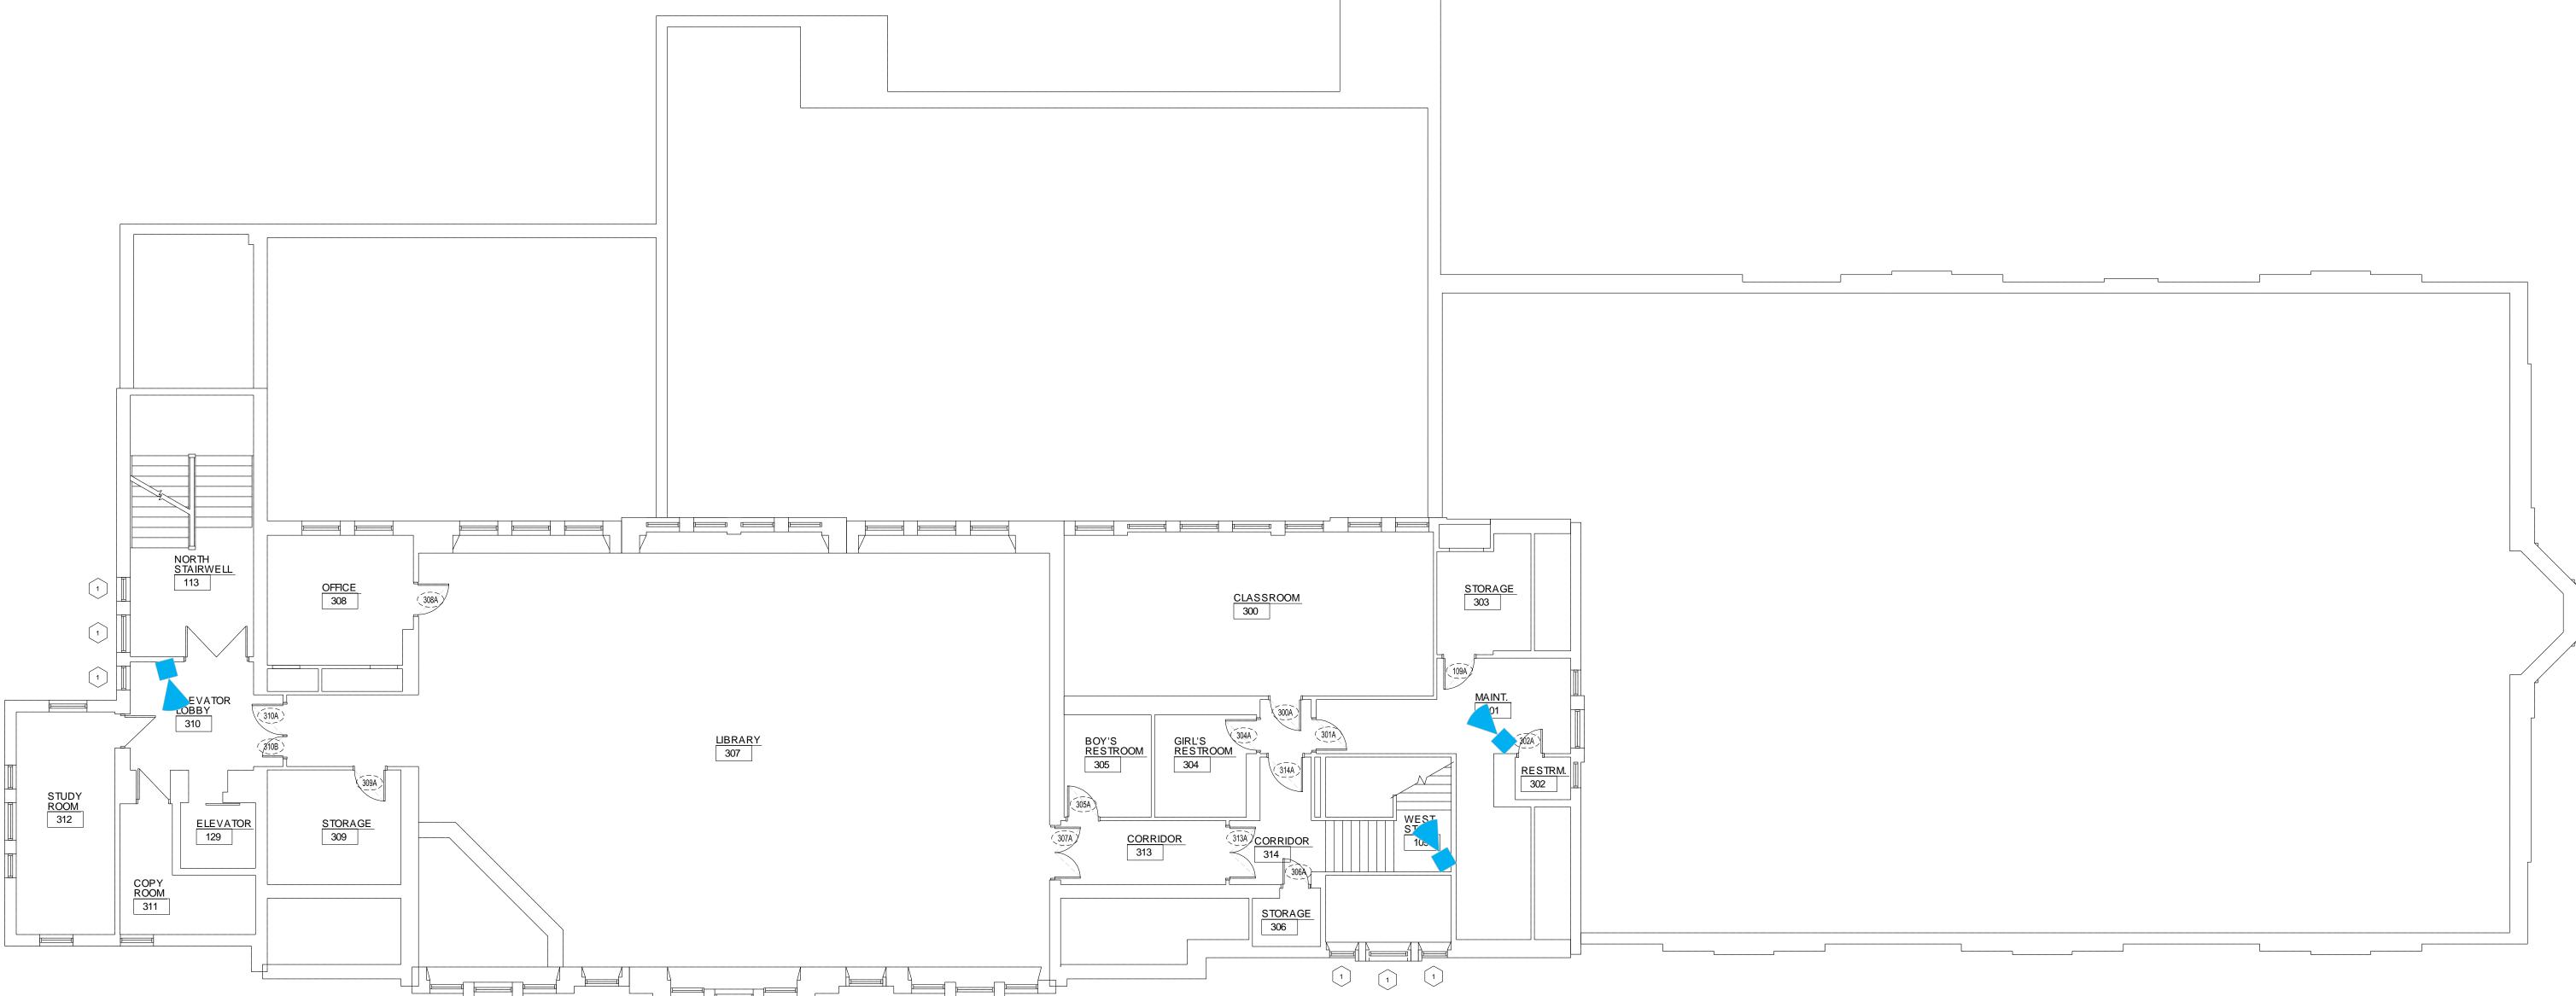
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KEY PLAN

DRAWN CHECKED

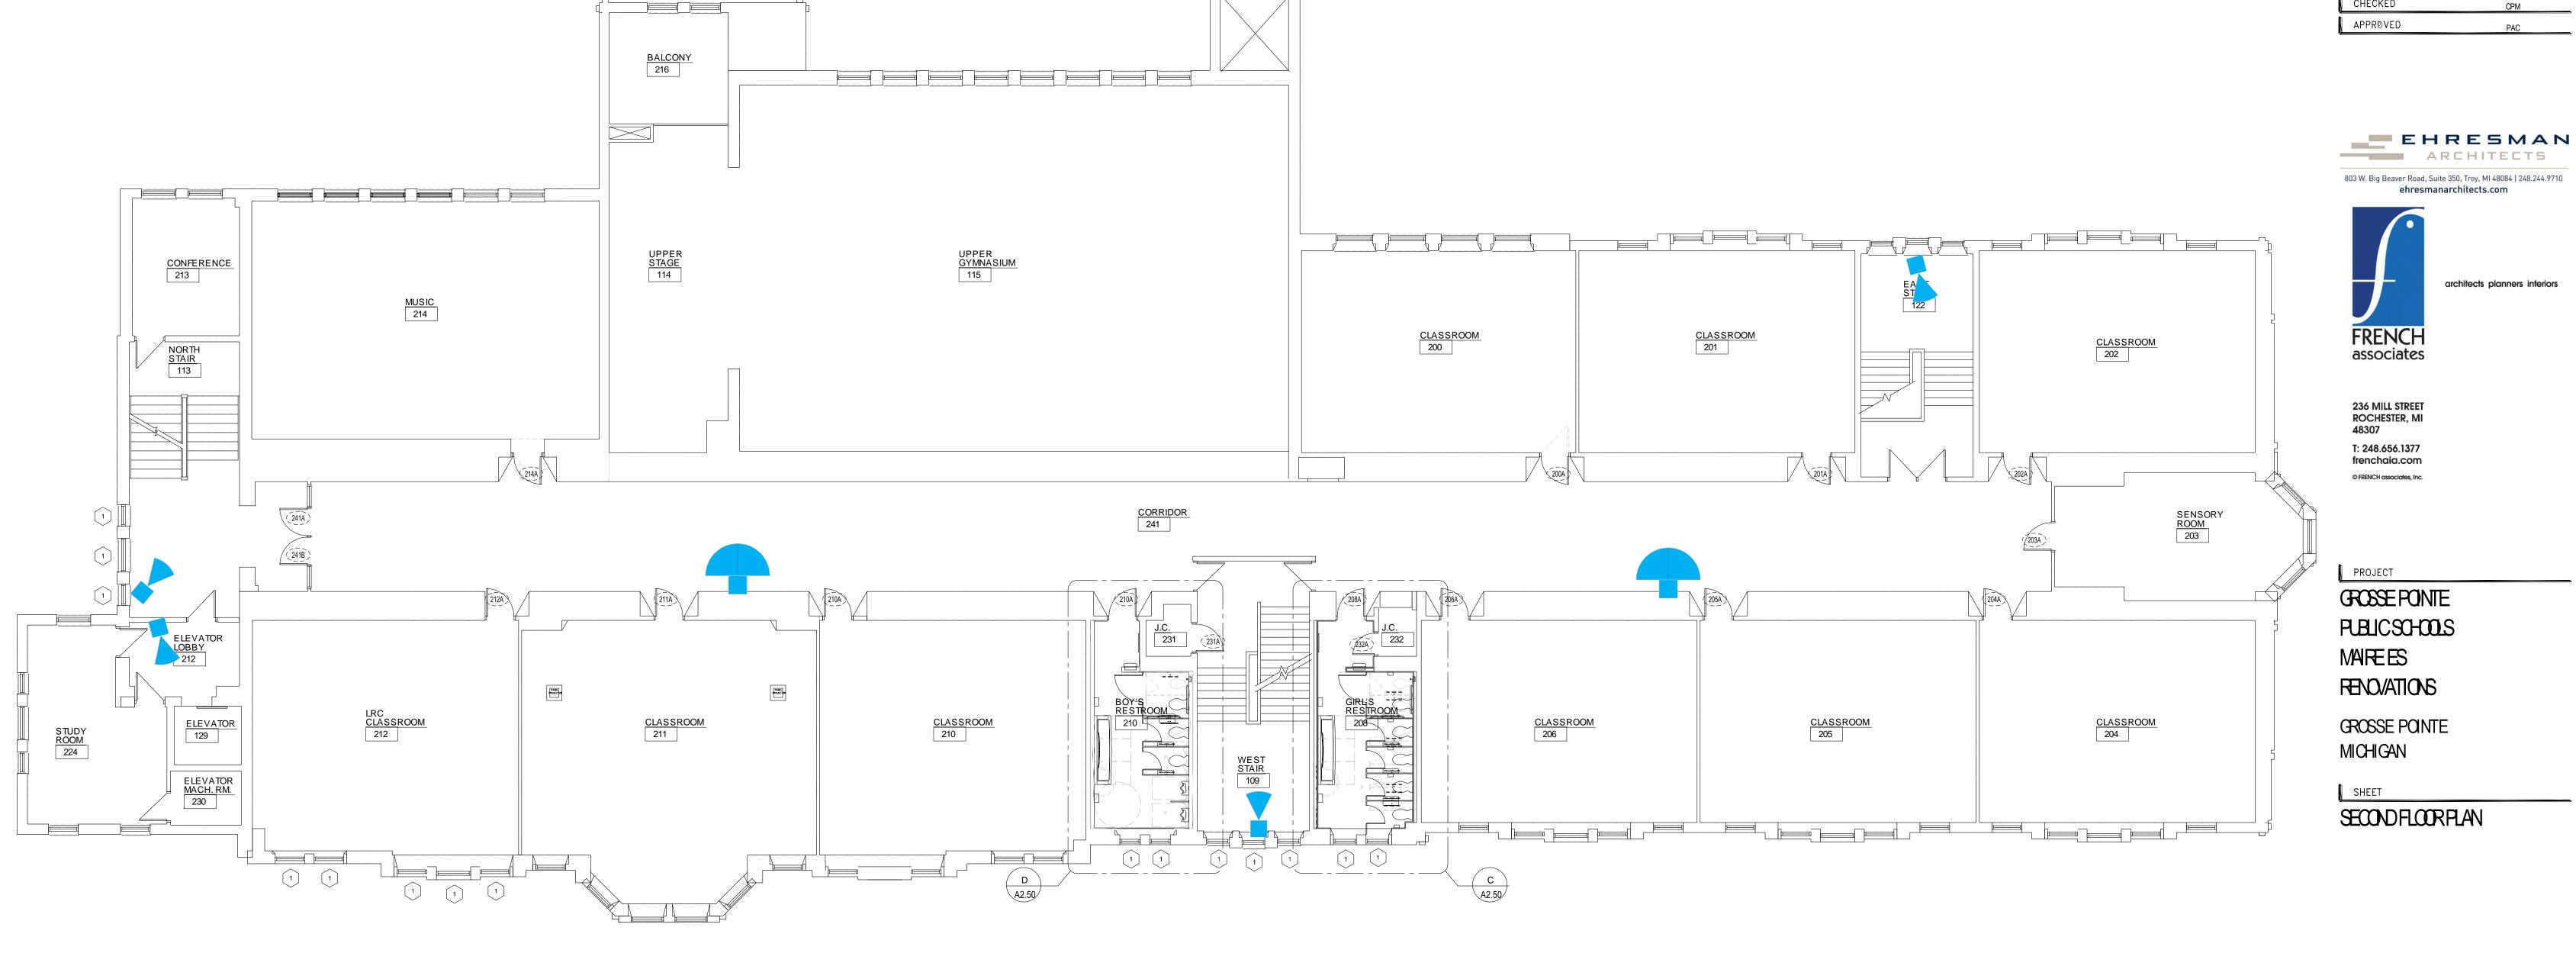



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PROJECT

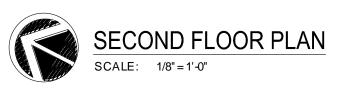GROSSE POINTE PLBLIC SOHOOLS MAREES REVOVATIONS

CROSSE POINTE MICHIGAN

SHEET


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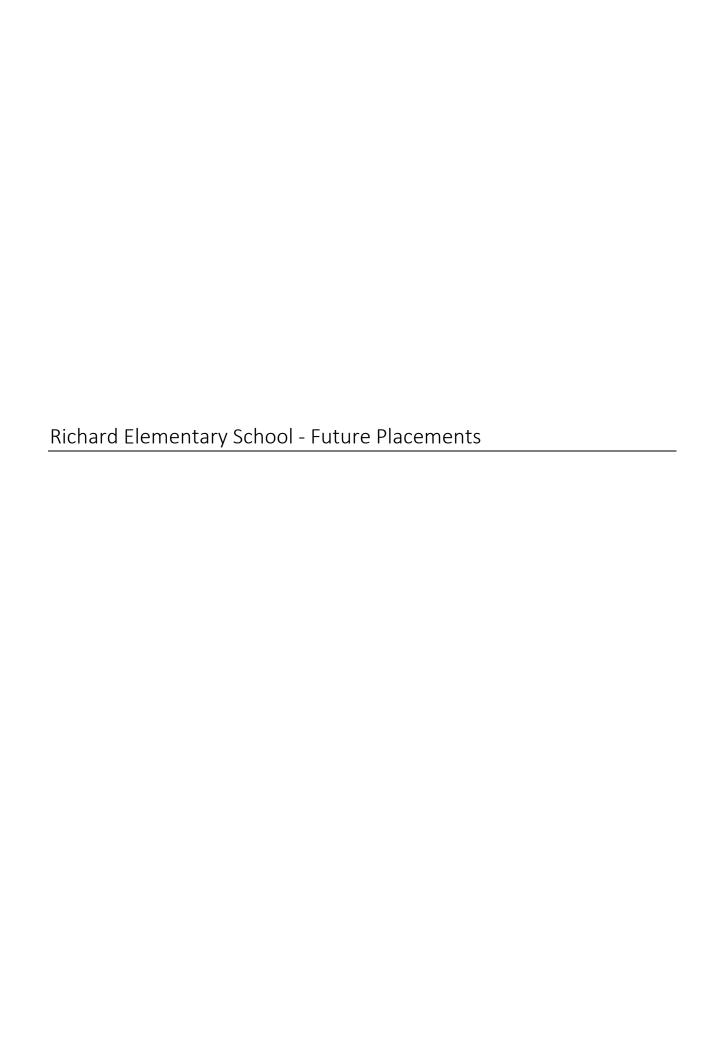
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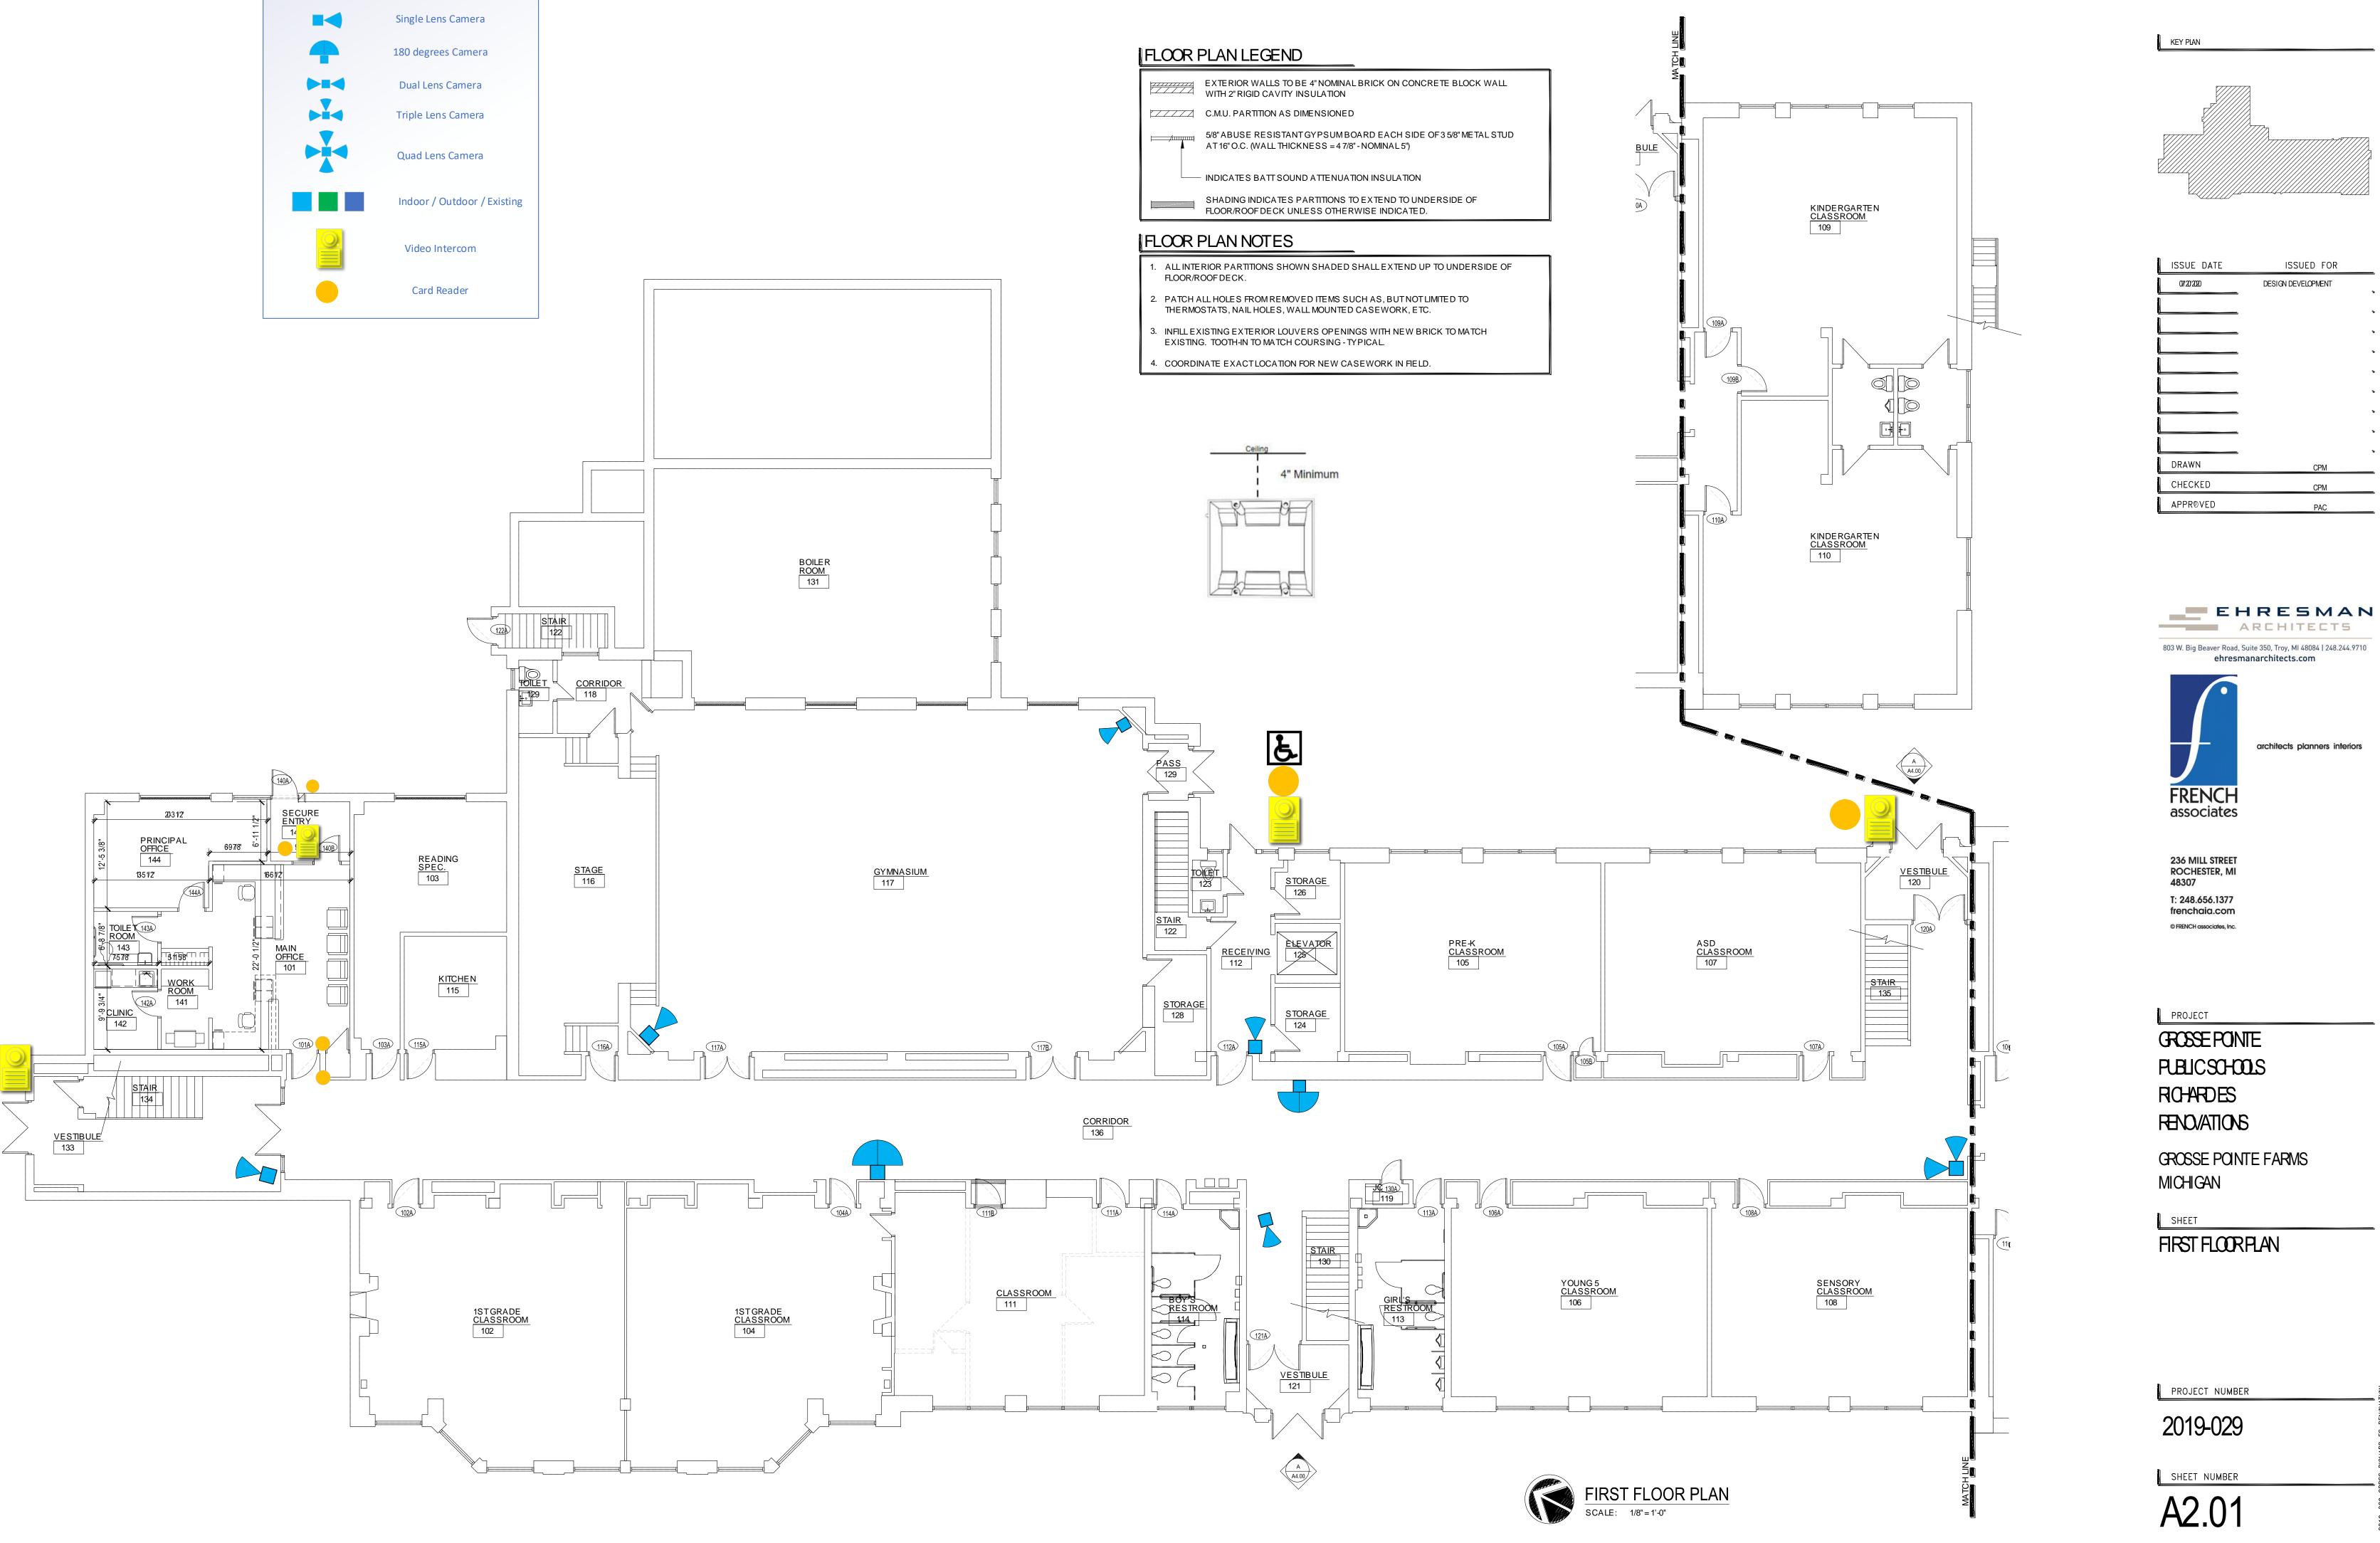
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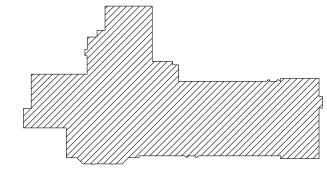
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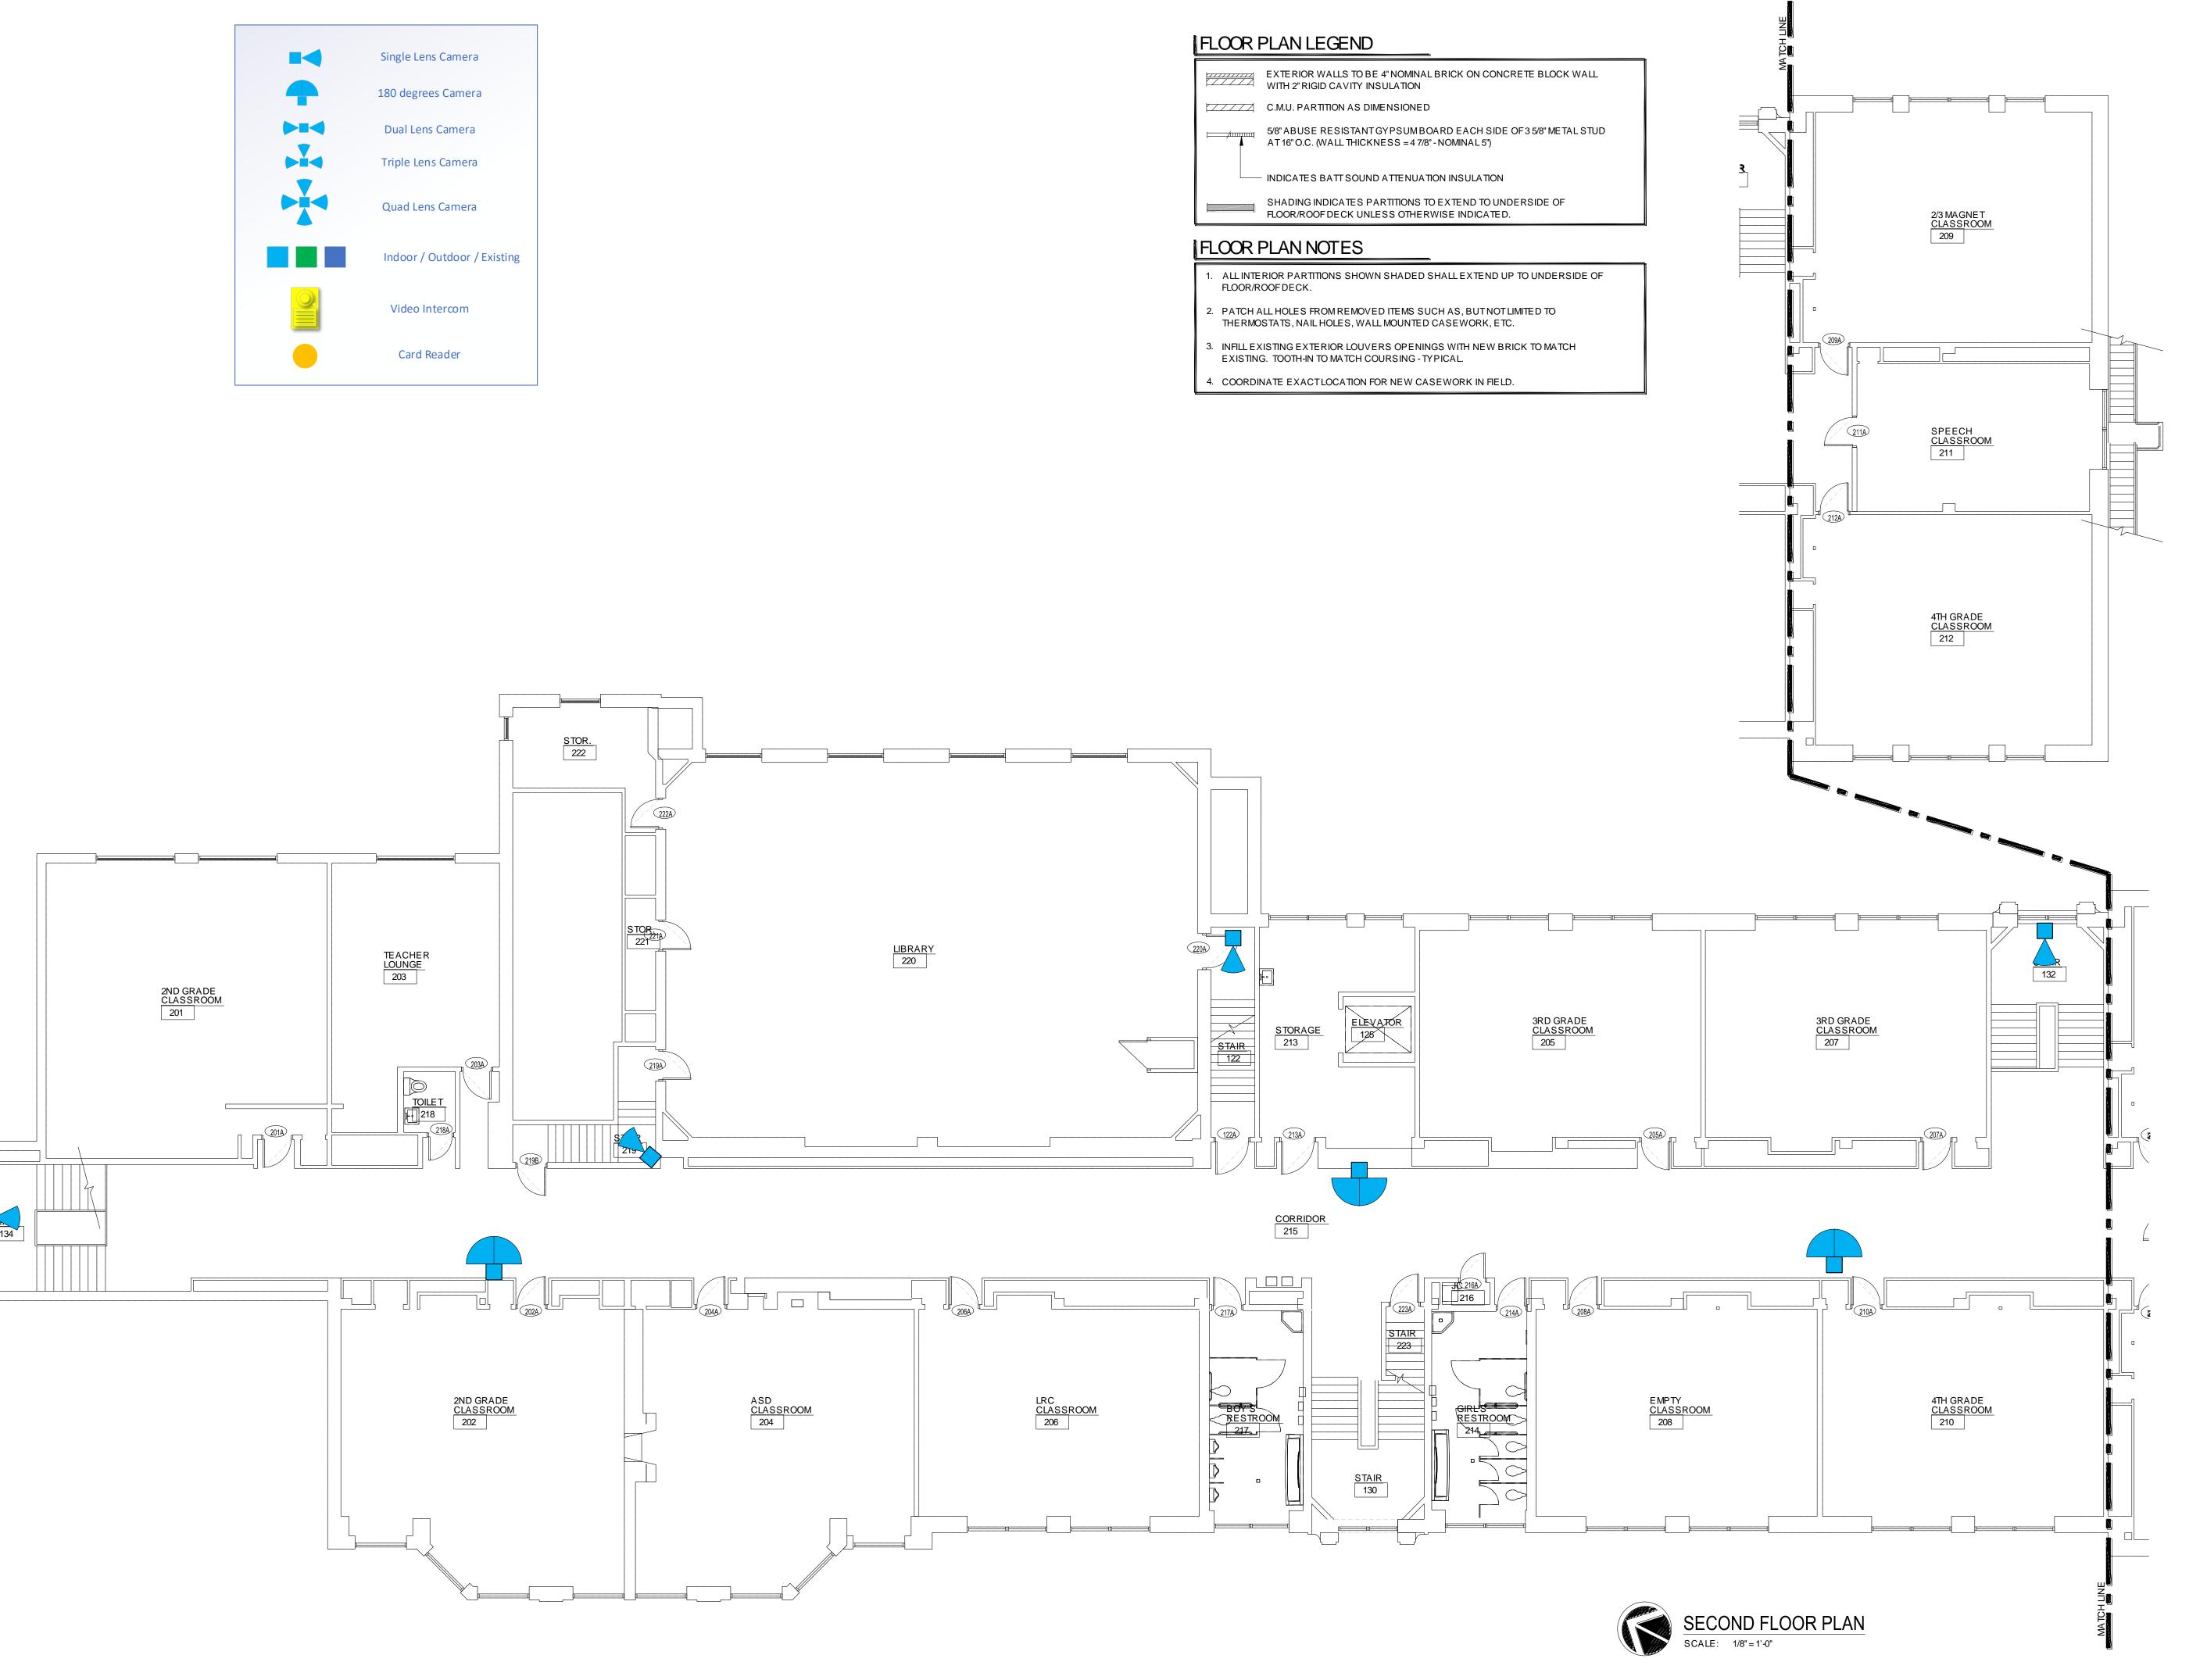







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KEY PLAN

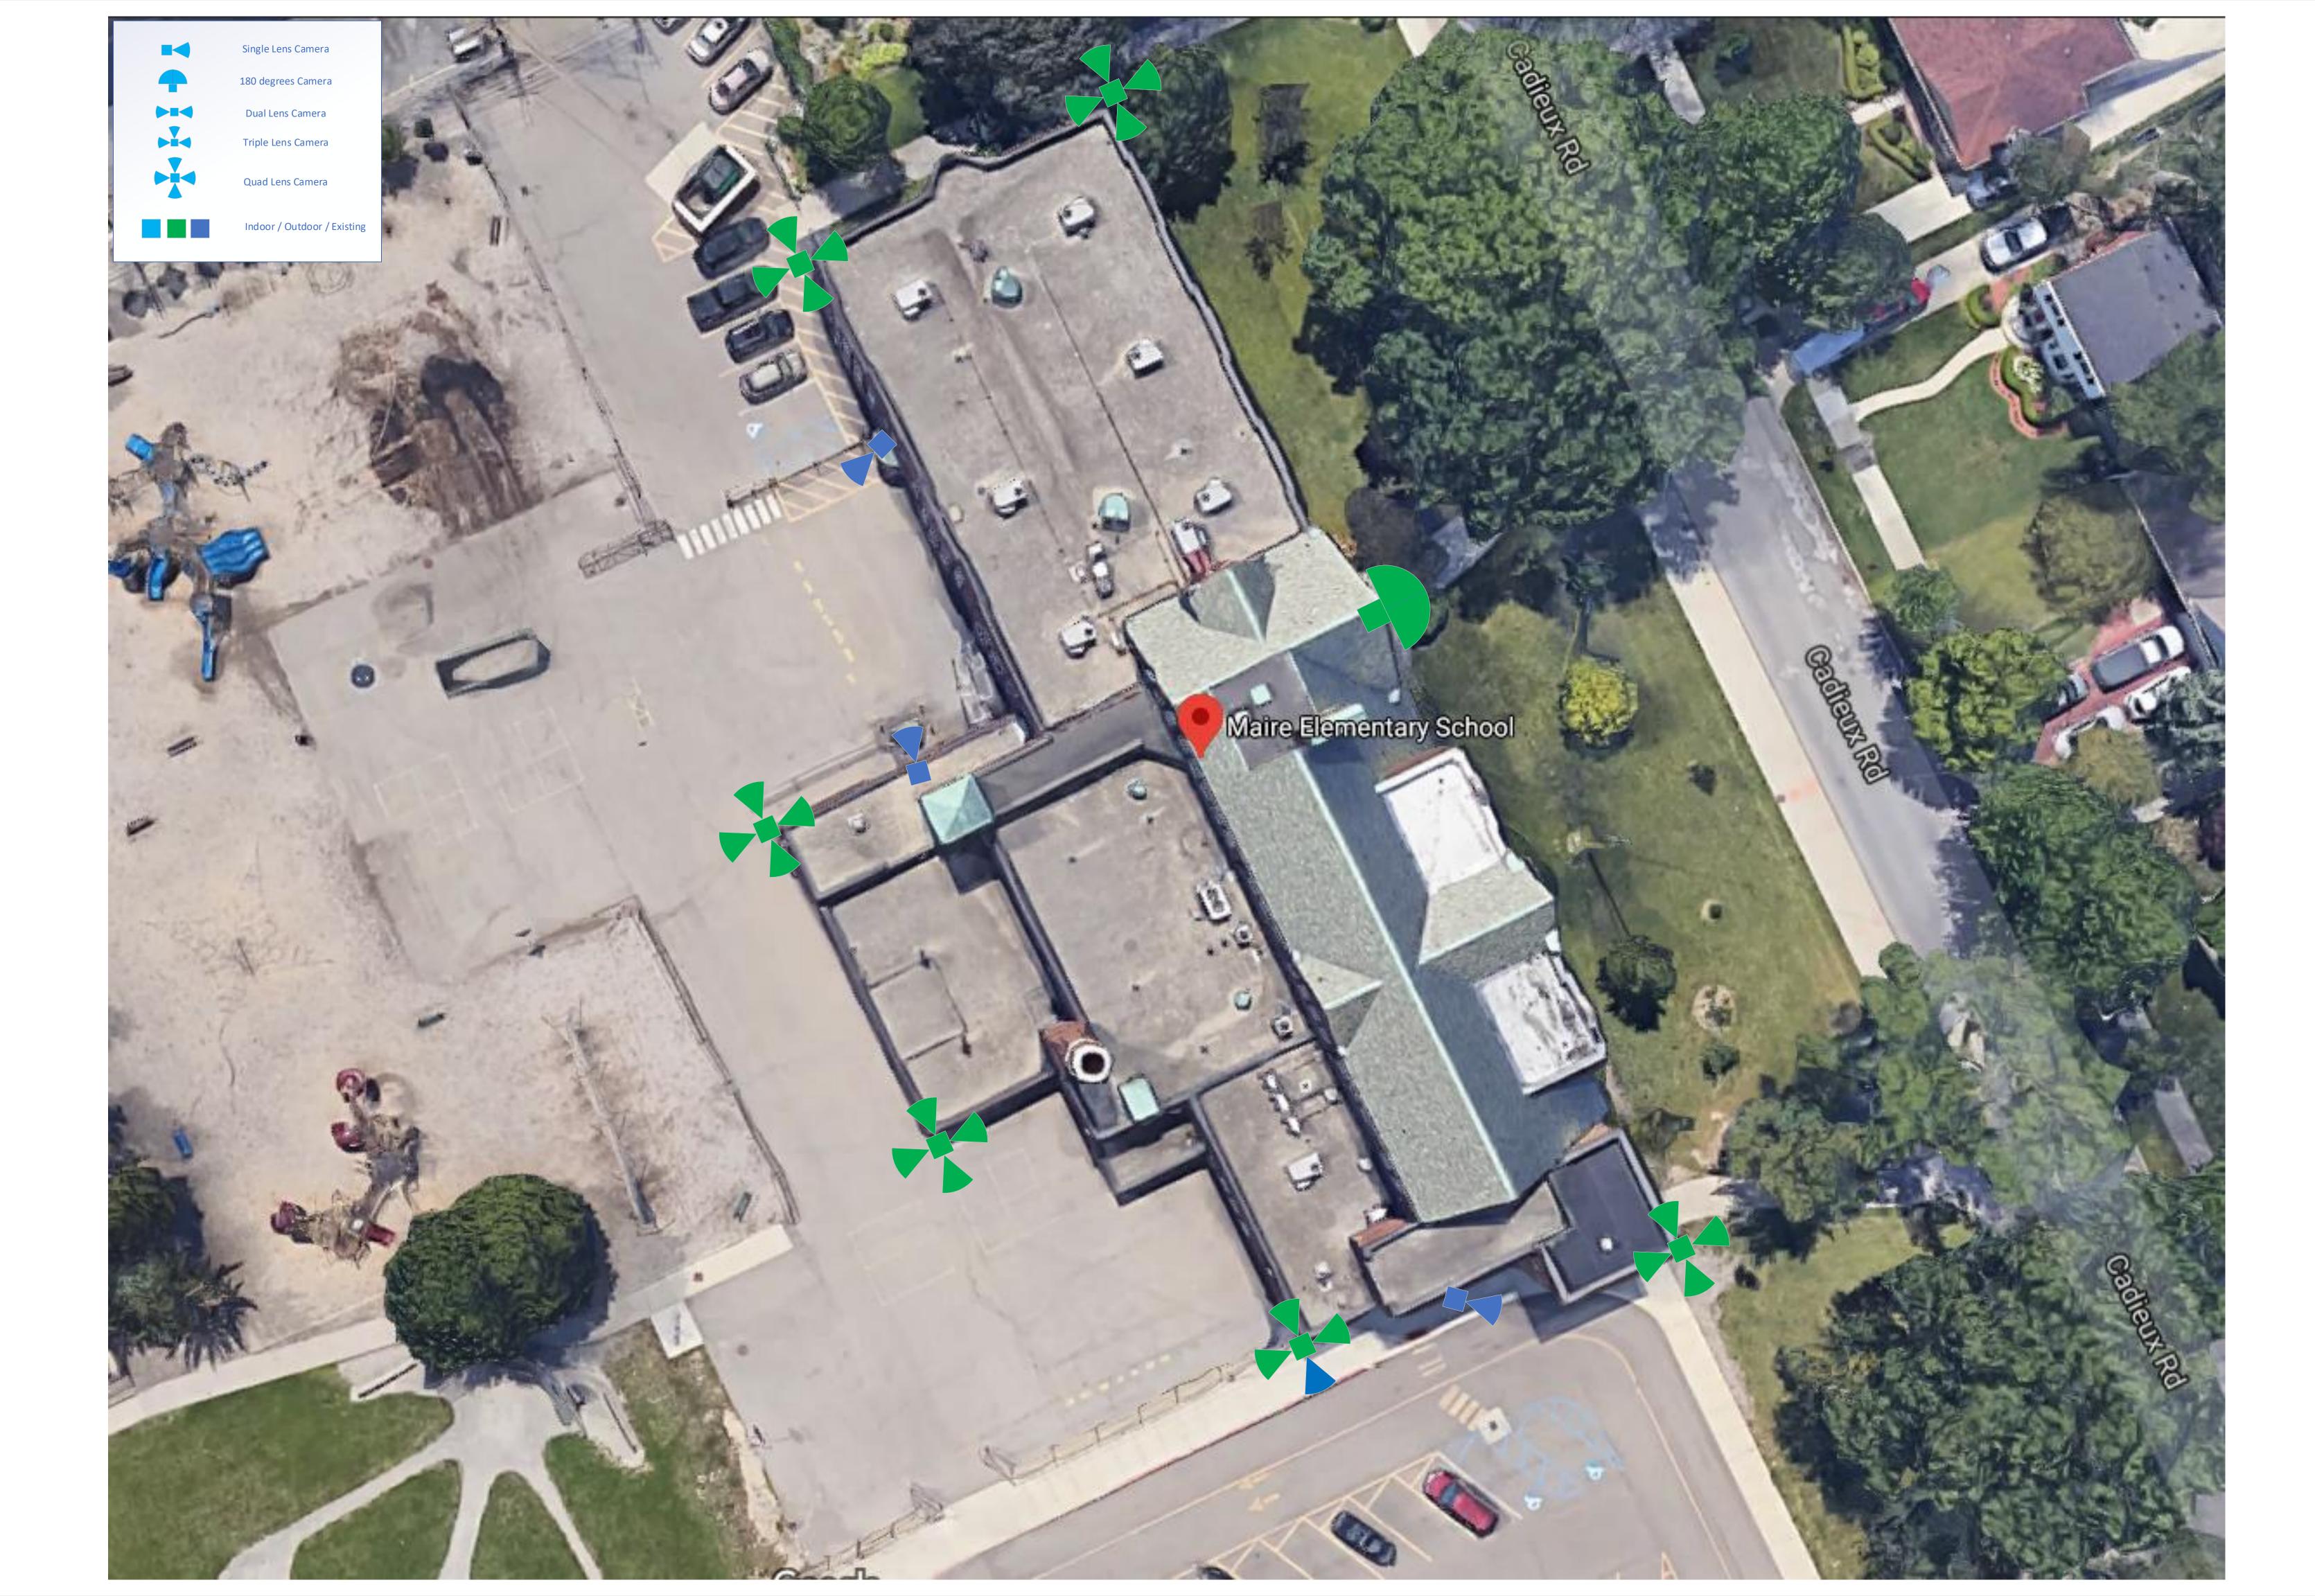

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PROJECT

GROSSE POINTE

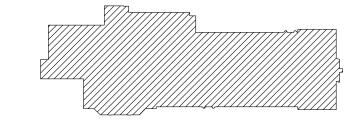PUBLIC SCHOOLS

RICHARDES

RENOVATIONS

GROSSE POINTE FARMS MICHIGAN


SHEET

SECONDFLOOR PLAN


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2019-029

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PROJECT

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RENOVATIONS

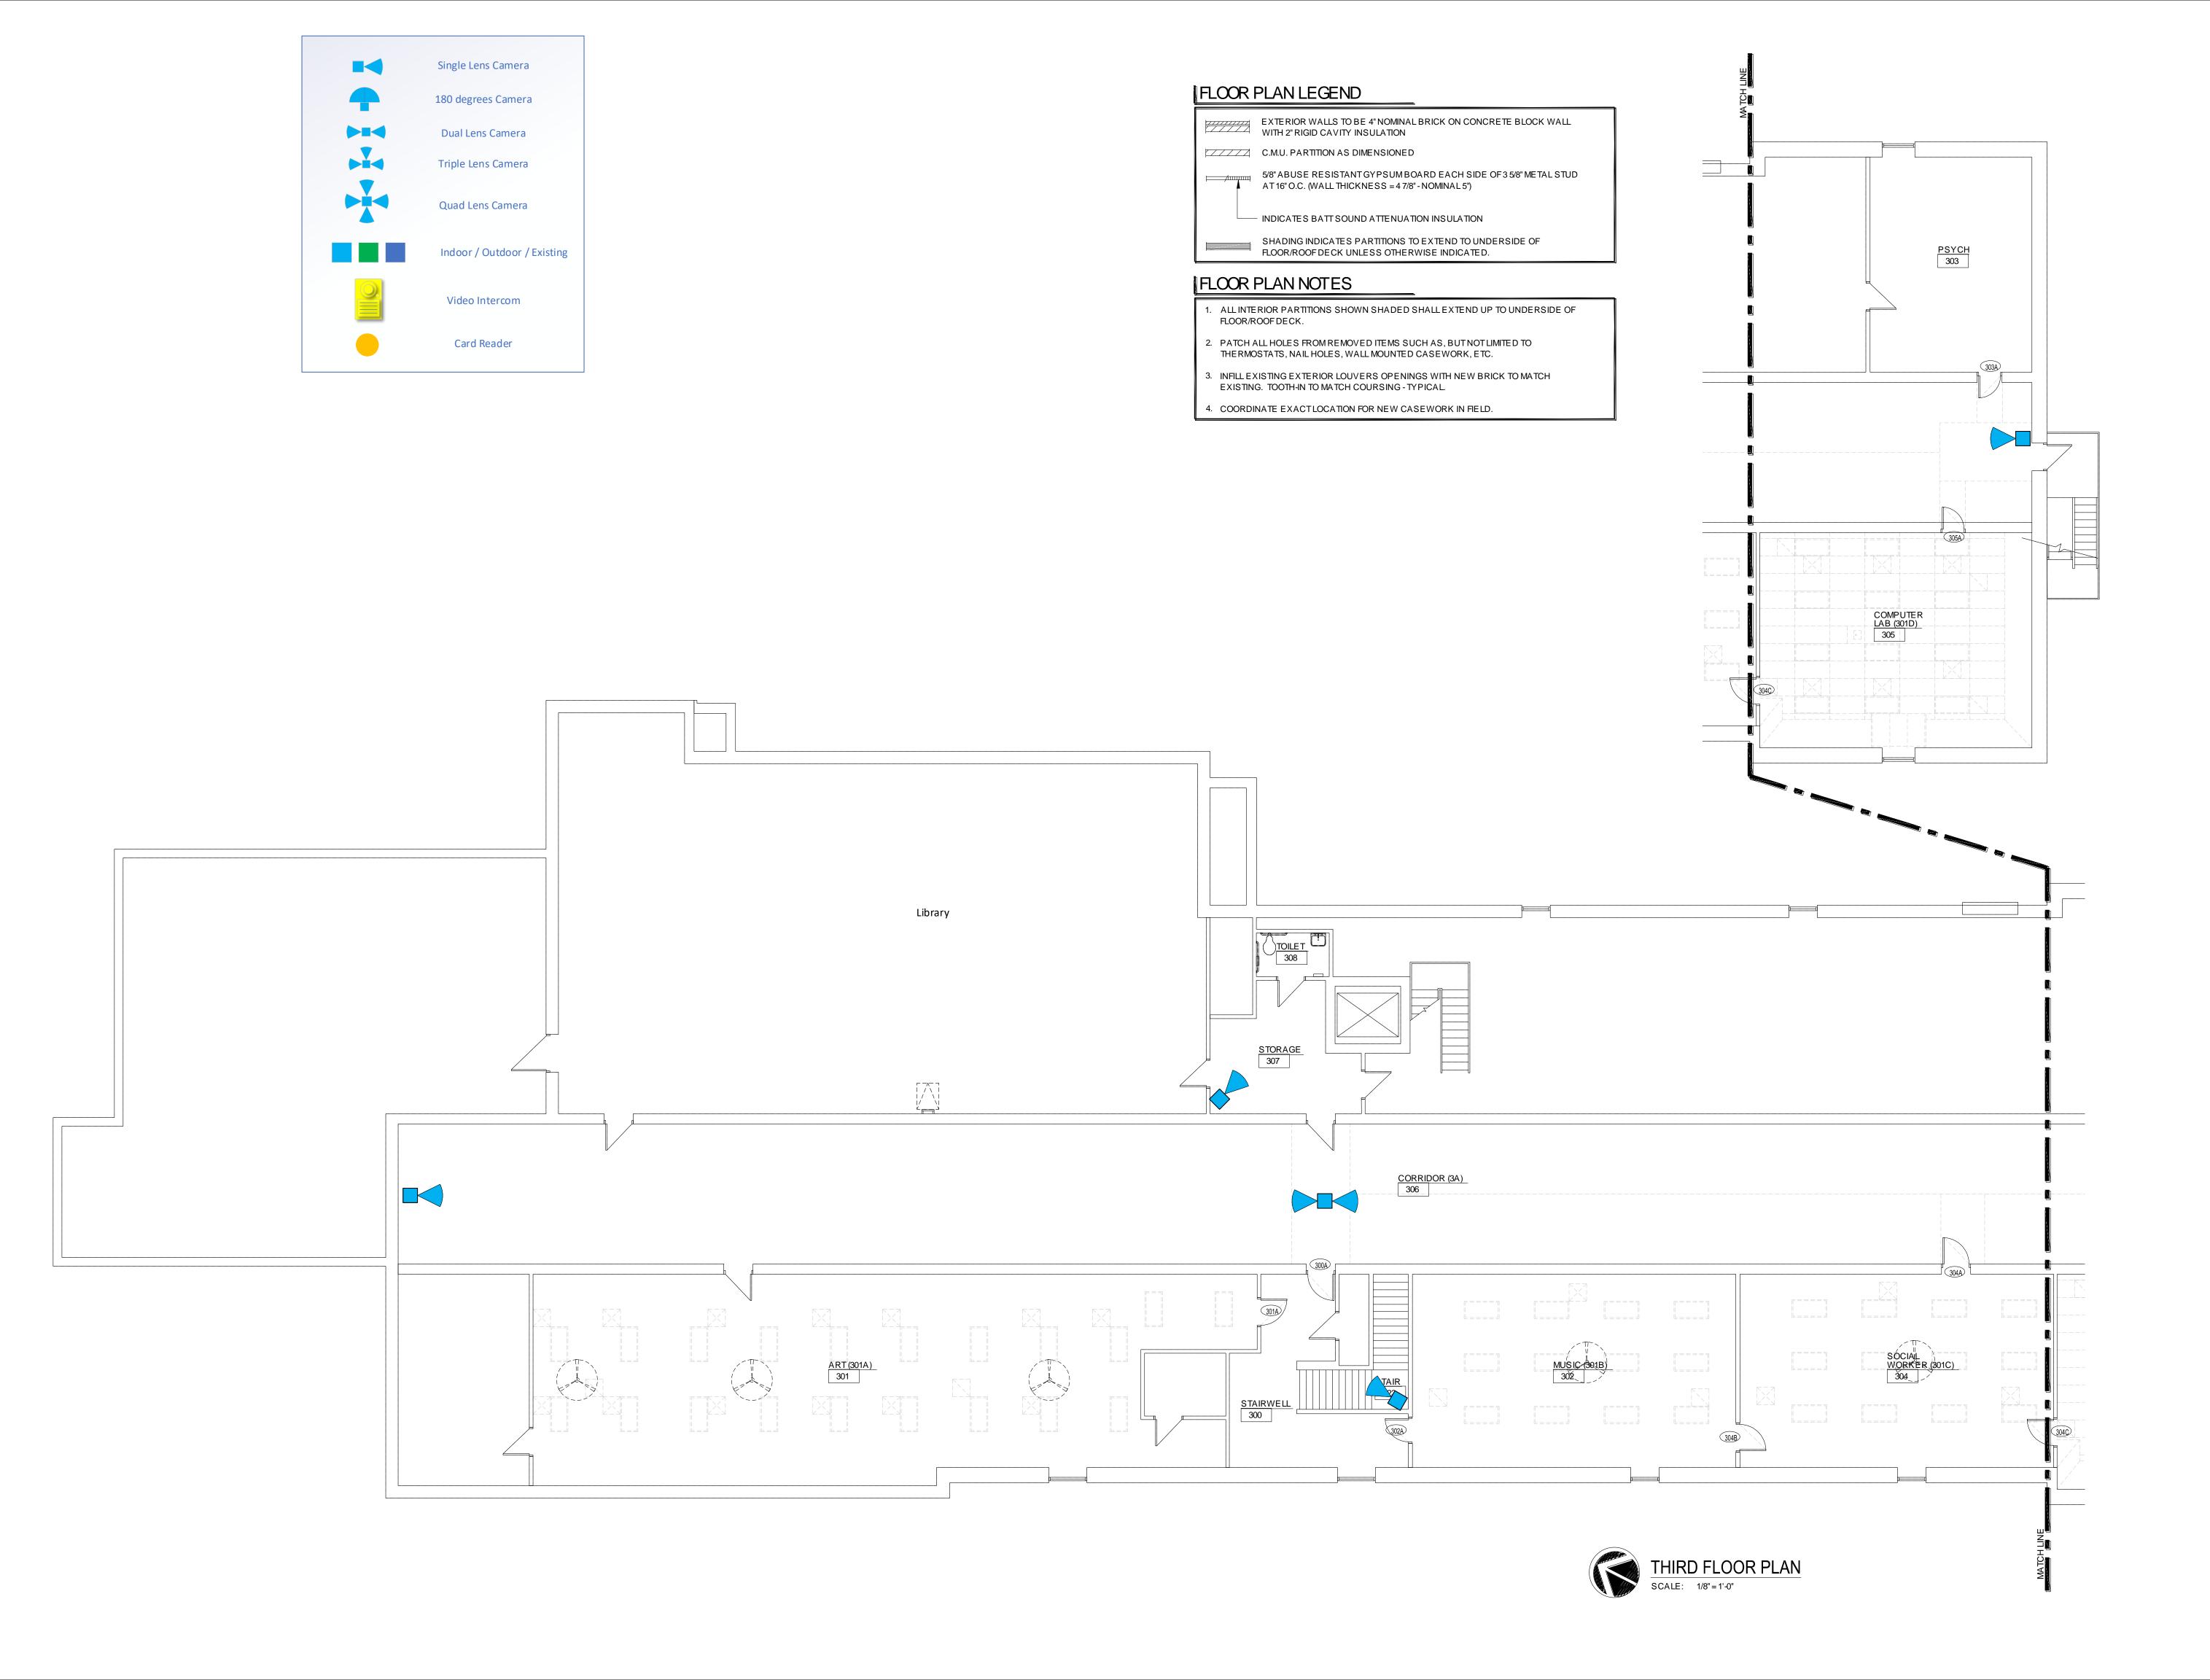GROSSE POINTE FARMS MICHIGAN


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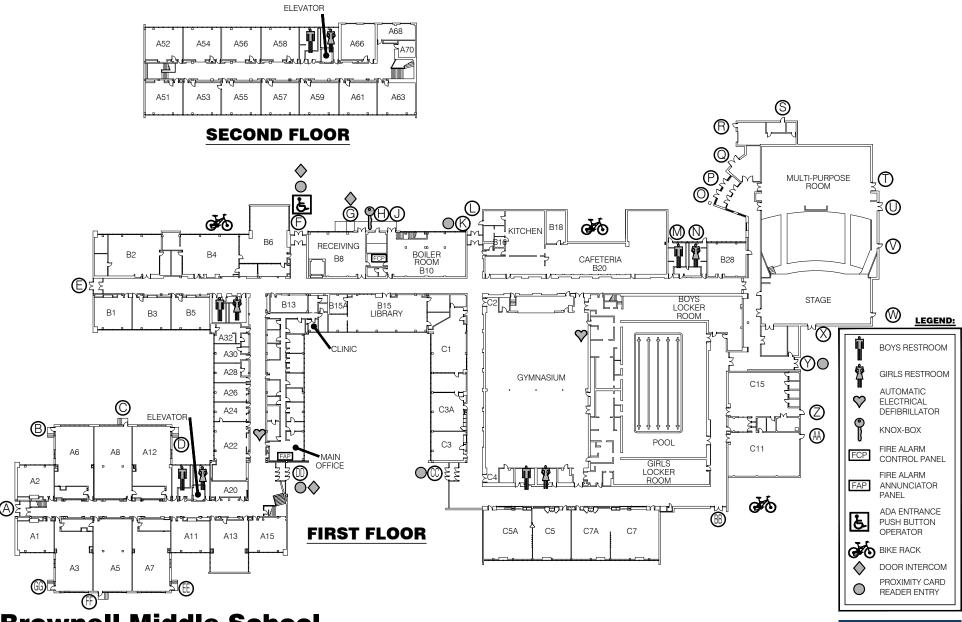
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SHEET NUMBER

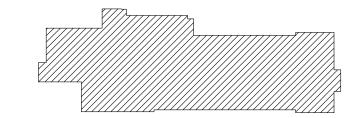







Brownell Middle School

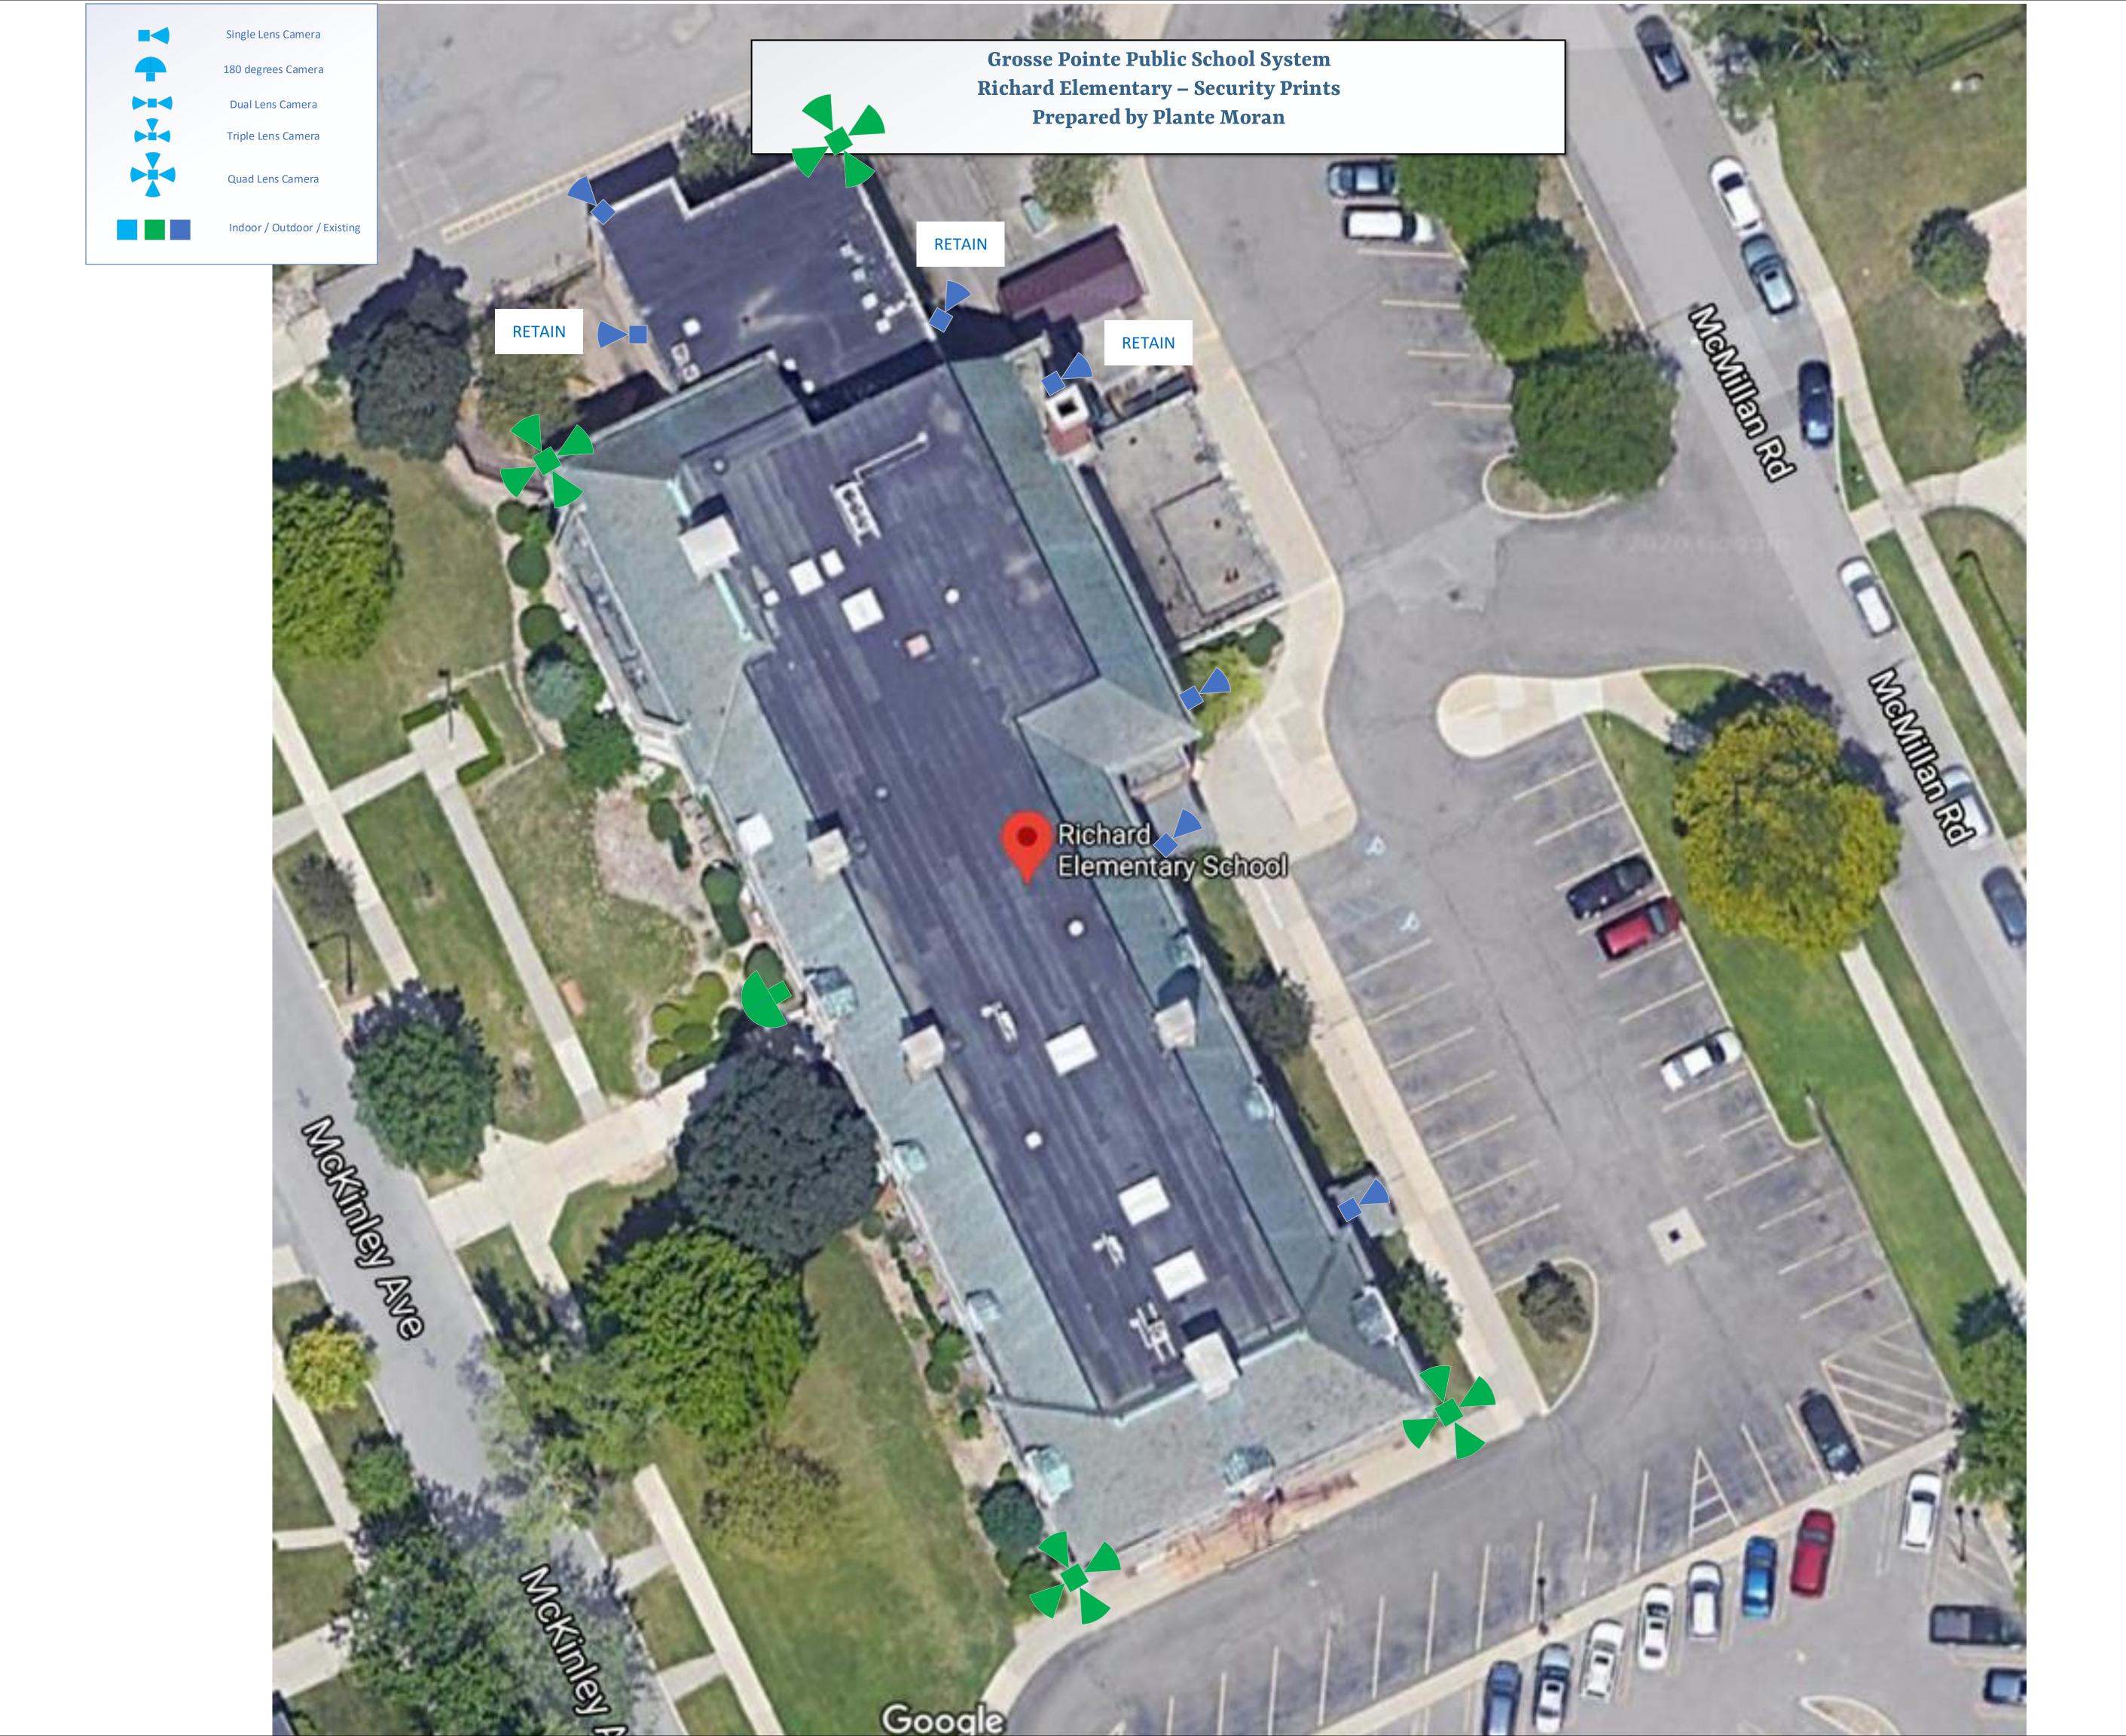
260 Chalfonte Grosse Pointe Farms MI 48236 313.432.3900

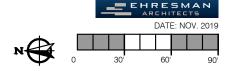

SECOND FLOOR

THIRD FLOOR

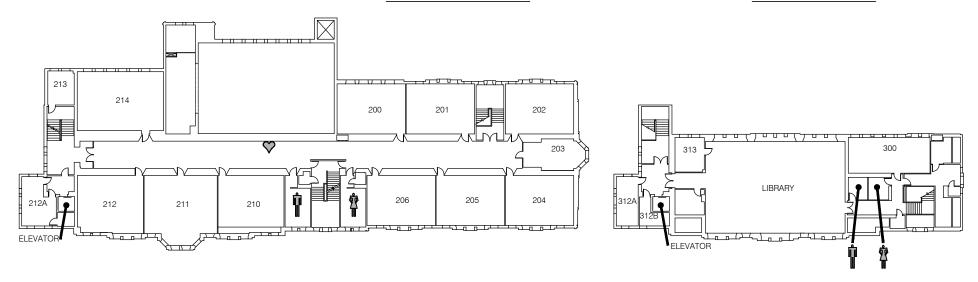

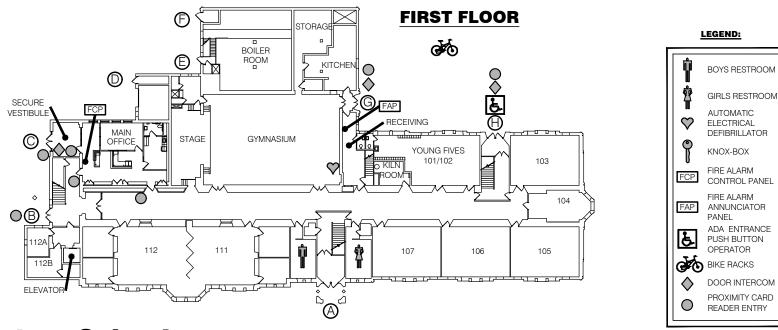


Maire Elementary School

740 Cadieux Grosse Pointe, MI 48230 313.432.4300




SECOND FLOOR

THIRD FLOOR

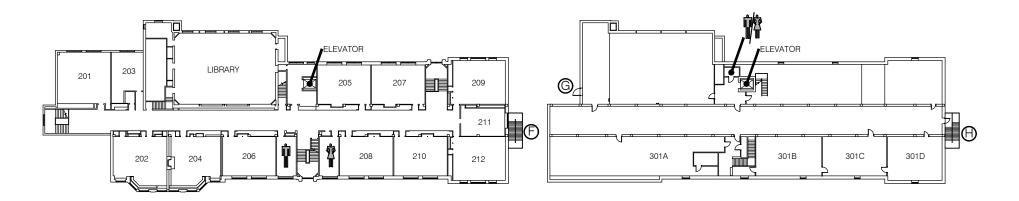

FIRST FLOOR

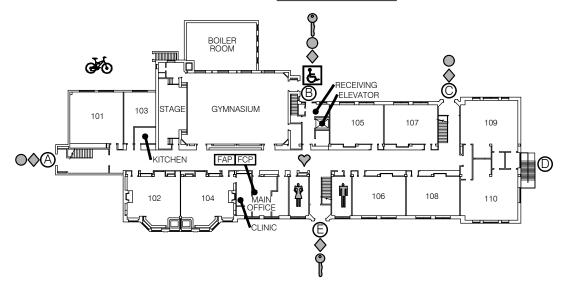

Richard Elementary School

176 McKinley Grosse Pointe Farms, MI 48236 313.432.4900

